

DESIGN AND CONSTRUCTION GROUP THE GOVERNOR NELSON A. ROCKEFELLER EMPIRE STATE PLAZA ALBANY, NY 12242

ADDENDUM NO. 1 TO PROJECT NO. 47602

PROVIDE RECREATIONAL MULTI-USE RAIL TRAIL FLOODWOOD TO TUPPER LAKE LAKE PLACID, NEW YORK

May 2, 2024

NOTE: This Addendum forms a part of the Contract Documents. Insert it in the Project Manual. Acknowledge receipt of this Addendum in the space provided on the Bid Form.

DRAWINGS

- 1. Revised Drawings:
 - a. Drawing No. G-004, G-006, C-103, C-506, C-507, C-601, S-401 to S-407, S-501 and S-502, noted "REVISED DRAWING 4/30/2024" accompanies this Addendum and supersedes the same numbered originally issued drawings.

END OF ADDENDUM

Brady Sherlock, P.E. Director, Division of Design Design & Construction

- THE CONTRACTOR IS ADVISED THAT ADDITIONAL NOTES WILL BE FOUND ON SUBSEQUENT SHEETS OF THE PLANS AND SUCH NOTES, WHILE PERTAINING TO THE SPECIFIC DRAWINGS THEY ARE PLACED ON, ALSO SUPPLEMENT THE GENERAL NOTES LISTED HEREIN.
- 4. IF THE DIRECTOR'S REPRESENTATIVE NOTIFIES THE CONTRACTOR OF ANY HAZARDOUS CONSTRUCTION PRACTICES, ALL OPERATIONS IN THE AFFECTED AREA SHALL BE DISCONTINUED AND IMMEDIATE ACTION SHALL BE TAKEN TO CORRECT THE SITUATION TO THE SATISFACTION OF THE DIRECTOR'S REPRESENTATIVE REFORE WORK IS RESUMED.
- ALL EXISTING TRAFFIC SIGNS REMOVED BY THE CONTRACTOR WITH A NYSDOT STICKER ON THE BACK OF THE PANEL SHALL BECOME THE PROPERTY OF THE NYSDOT. SIGNS WILL BE STORED AND LOCAL STATE RESIDENCY NOTIFIED FOR PICKUP. ALL OTHER EXISTING SIGNS SHALL BECOME THE PROPERTY OF APPLICABLE MUNICIPALITY.
- ALL WORK SHALL BE DONE IN STRICT COMPLIANCE WITH ALL APPLICABLE NATIONAL, STATE, AND LOCAL CODES, STANDARDS, ORDINANCES, RULES, AND REGULATIONS.
- 7. SUBMITTALS, CATALOG CUTS, SAMPLES, AND SHOP DRAWINGS MUST BE RECEIVED, REVIEWED AND APPROVED BY THE DIRECTOR'S REPRESENTATIVE PRIOR TO ORDERING OR FABRICATION OF MATERIALS AND PRIOR TO INSTALLATION OF MATERIALS. FAILURE TO DO SO MAY RESULT IN TIME DELAYS. THE CONTRACTOR WILL NOT BE ENTITLED TO COMPENSATION FOR SAID TIME DELAYS, REMOVALS, OR REPLACEMENTS.
- 8. THE CONTRACTOR TO PROVIDE AN ACI CERTIFIED CONCRETE FLAT WORK FINISHER TO SUPERVISE ALL HAND FINISHING PER ACI. CERTIFICATION SHALL BE PROVIDED TO THE DIRECTOR'S REPRESENTATIVE.
- 9. HISTORIC FEATURES HAVE BEEN IDENTIFIED AND ARE LOCATED WITHIN THE PROJECT LIMITS. THE CONTRACTOR TO CONDUCT ITS OPERATION IN SUCH A MANNER TO PREVENT ANY DAMAGE TO THESE FEATURES. PRIOR TO CONSTRUCTION, ALL EXISTING HISTORIC FEATURES WITHIN THE PROJECT LIMITS SHALL BE IDENTIFIED BY THE DIRECTOR'S REPRESENTATIVE OR OWNER. THE HISTORIC FEATURES WILL BE FLAGGED IN THE FIELD PRIOR TO CONSTRUCTION BY NYSDEC AND/OR THE DIRECTOR'S REPRESENTATIVE.
- 10. THE CONTRACTOR TO COORDINATE AND CONFIRM ALL SPECIFIC TREE REMOVAL LOCATIONS WITHIN THE PROJECT LIMITS WITH THE DIRECTOR'S REPRESENTATIVE, PRIOR TO REMOVING TREES.

STREAM PROTECTION NOTES:

VARIOUS STREAMS ARE CLASSIFIED AS CLASS A, STANDARD A(T) WATERBODIES THROUGHOUT THE PROJECT LIMITS.

- 1. DURING THE COURSE OF CONSTRUCTION, THE CONTRACTOR TO CONDUCT ITS OPERATIONS
 IN SUCH A MANNER TO PREVENT ANY DAMAGE TO ANY WATERBODY, INCLUDING WETLANDS,
 FROM DIRECT OR INDIRECT POLLUTION BY DEBRIS, SEDIMENTATION OR OTHER FOREIGN MATERIAL,
 OR FROM THE MANIPULATION OF EQUIPMENT AND/OR MATERIALS IN OR NEAR SUCH WATERBODIES.
 NO WATER SHALL BE RETURNED DIRECTLY TO THE WATERBODY WHICH HAS BEEN USED FOR WASH
 PURPOSES OR OTHER SIMILAR OPERATIONS, WHICH CAUSE THIS WATER TO BE CONTAMINATED WITH
 SAND. SLIT J. CEMENT. OIL OR OTHER IMPURITIES.
- 2. DURING REMOVAL OPERATIONS, THE CONTRACTOR TO NOT BE ALLOWED TO DROP WASTE CONCRETE, DEBRIS, AND OTHER MATERIAL IN ANY WATERWAY, CHANNEL, SIDE POOL OR ANYWHERE ON COUNTY OR NYSDEC PROPERTY UNLESS APPROVED BY THE COUNTY OR NYSDEC. PLATFORMS, NETS, SCREENS, OR OTHER PROTECTIVE DEVICES SHALL BE USED TO CATCH THE MATERIAL. IF THE DIRECTOR'S REPRESENTATIVE DETERMINES THAT ADEQUATE PROTECTIVE DEVICES ARE NOT BEING EMPLOYED, THE WORK SHALL BE SUSPENDED UNTIL ADEQUATE PROTECTION IS PROVIDED.
- 3. PRIOR TO STARTING ANY WORK WITHIN 50' OF THE WATER'S EDGE, THE CONTRACTOR TO COORDINATE WITH THE DIRECTOR'S REPRESENTATIVE. THE DIRECTOR'S REPRESENTATIVE SHALL CONSULT WITH THE REGIONAL CONSTRUCTION ENVIRONMENTAL COORDINATOR AND THE NEW YORK STATE DEPARTMENT OF ENVIRONMENTAL CONSERVATION REGION 3 HABITAT PROTECTION MANAGER.

ENVIRONMENTAL NOTES:

- ALL DISTURBED UNPAVED AREAS WITHIN THE DESIGNATED WORK LIMITS SHALL BE GRADED, FERTILIZED, SEEDED AND MULCHED AS SPECIFIED.
- 2. DURING CONSTRUCTION, NO WET OR FRESH CONCRETE OR LEACHATE SHALL BE ALLOWED TO ESCAPE INTO THE WATERS OF NEW YORK STATE, NOR SHALL WASHINGS FROM REDI-MIX TRUCKS, MIXERS OR OTHER DEVICES BE ALLOWED TO ENTER ANY WETLAND OR WATERS. DESIGNATED WASH OUT AREAS TO BE APPROVED BY THE DIRECTOR'S REPRESENTATIVE.
- 3. SPILLAGE OF OIL AND HAZARDOUS SUBSTANCES IS ESPECIALLY PROHIBITED BY SECTION 311 OF THE CLEAN WATER ACT OF 1977. MEASURES INCLUDING PROPER MAINTENANCE OF CONSTRUCTION EQUIPMENT, DESIGNATING FUEL/HAZARDOUS SUBSTANCES, HANDLING AREAS TO ALLOW SPILLS TO BE CONTAINED BEFORE REACHING THE WATERWAY, INSTRUCTING PERSONNEL NOT TO DISPOSE OF OIL AND OTHER SUCH MATERIALS INTO DRAINS OR INTO THE WATERWAY DIRECTLY, AND OTHER NECESSARY PROCEDURES SHALL BE IMPLEMENTED PRIOR TO ANY CONSTRUCTION ACTIVITIES. IF, IN SPITE OF SUCH PLANNING, OIL/HAZARDOUS SUBSTANCES ARE SPILLED INTO A WATERCOURSE, IMMEDIATE NOTIFICATION SHALL BE GIVEN TO THE N.Y.S. DEPARTMENT OF ENVIRONMENTAL CONSERVATION AT TELEPHONE NUMBER (518) 457-7362 AND THE NATIONAL RESPONSE CENTER AT TELEPHONE NUMBER 1-800-424-8802. A CONTAINMENT BOOM AND A SUPPLY OF HAY, STRAW, OR OTHER ABSORBENT SHALL BE RETAINED SO THAT IT MAY BE RAPIDLY DEPLOYED TO SOAK UP ANY POSSIBLE SPILLAGE. PENDING ENVIRONMENTAL CONSERVATION AND/OR NYCOEP ARRIVAL ON THE SCENE, THE USE OF CHEMICAL DISPERSING AGENTS AND EMULSIFIERS IS NOT AUTHORIZED WITHOUT PRIOR, SPECIFIC, FEDERAL, OR STATE APPROVAL.
- 4. ANY MATERIAL ENTERING THE WATER, FOR ANY REASON WHATSOEVER, WHICH IS NOT PART OF INTENDED WORK, SHALL BE REMOVED AND DISPOSED OF PROPERLY IN ACCORDANCE WITH CURRENT NYSDEC REGULATIONS.
- IF CONTRACTOR CHOOSES TO SPOIL MATERIAL OUTSIDE OF THE LOCATIONS NOTED IN THE CONTRACT DOCUMENTS, CONTRACTOR TO OBTAIN APPROVAL FROM ALL STATE AND FEDERAL PERMITTING AGENCIES TO USE THE PROPERTY.

UTILITY NOTES:

- LOCATION OF UTILITIES, PUBLIC AND/OR PRIVATE, INDICATED ON THE PLANS AS EXISTING AND/OR TO BE CONSTRUCTED ARE APPROXIMATE ONLY. THEIR EXACT LOCATION SHALL BE DETERMINED IN THE FIELD. ADDITIONAL UTILITY LINES, WHETHER ABANDONED OR IN SERVICE, MAY EXIST AND IT SHALL BE THE CONTRACTOR'S RESPONSIBILITY TO CONDUCT HIS OR HER OPERATIONS, AND TAKE NECESSARY PRECAUTIONS SUCH THAT INTERFERENCE WITH OR DAMAGE TO THESE OR OTHER FACILITIES DURING THE COURSE OF CONSTRUCTION IS PREVENTED.
- PRIOR TO CONSTRUCTION, THE CONTRACTOR TO CALL "DIG SAFELY" (1-800-962-7962) TO HAVE UNDERGROUND UTILITIES LOCATED.
- 3. EXPLORATORY EXCAVATIONS SHALL BE PERFORMED AS NEEDED BY THE CONTRACTOR TO VERIFY EXISTING CONDITIONS PRIOR TO WORK IN CONGESTED UTILITY AREAS. ALL TEST PITS IDENTIFIED ON THESE DRAWINGS ARE TO BE COMPLETED AND TEST PIT LOGS SUBMITTED TO THE DIRECTOR'S REPRESENTATIVE WITHIN FOURTEEN (14) DAYS FOLLOWING NOTICE TO PROCEED, UNLESS OTHERWISE DIRECTED BY THE DIRECTOR'S REPRESENTATIVE.
- 4. THE QUALITY OF THE UNDERGROUND UTILITY INFORMATION ON THE PLANS IS QUALITY LEVEL "D". FOUR SEPARATE QUALITY LEVELS OF SUBSURFACE UTILITY FACILITY INFORMATION ARE CENERALLY RECOGNIZED AND ARE AS FOLLOWS:
- QUALITY LEYEL A (QLA): QUALITY LEVEL A IS THE HIGHEST DEGREE OF ACCURACY. THE INFORMATION SHOWN ON THE PLANS HAS BEEN OBTAINED BY THE ACTUAL EXPOSURE (OR VERIFICATION OF PREVIOUSLY EXPOSED AND SURVEYED UTILITY FACILITIES) OF SUBSURFACE UTILITIES, USING (TYPICALLY) MINIMALLY INTRUSIVE EXCAVATION EQUIPMENT TO DETERMINE THEIR PRECISE HORIZONTAL AND VERTICAL POSITIONS, AS WELL AS THEIR OTHER UTILITY FACILITY ATTRIBUTES. (SHOWN AS QLA)
- QUALITY LEVEL B (QLB): QUALITY LEVEL B IS THE SECOND HIGHEST DEGREE OF ACCURACY. THE
 INFORMATION SHOWN ON THE PLANS HAS BEEN OBTAINED THROUGH THE APPLICATION OF APPROPRIATE
 SURFACE GEOPHYSICAL METHODS (I.E., UNDERGROUND CAMERAS, RADAR, SONAR, TONE OUTS, ETC.) TO
 IDENTIFY THE EXISTENCE AND APPROPRIATE HORIZONTAL POSITION OF SUBSURFACE UTILITY FACILITIES,
 QUALITY LEVEL B DATA ARE REPRODUCIBLE BY SURFACE GEOPHYSICS AT ANY POINT OF THEIR
 DEPICTION, THE INFORMATION WAS SURVEYED TO APPLICABLE TOLERANCES AND REDUCED ONTO THE
 PLANS, NO EXCAVATIONS WERE PERFORMED. (SHOWN AS QLB)
- QUALITY LEVEL C (QLC): QUALITY LEVEL C IS THE THIRD HIGHEST DEGREE OF ACCURACY. THE
 INFORMATION SHOWN ON THE PLANS HAS BEEN OBTAINED BY SURVEYING AND PLOTTING VISIBLE
 ABOVE-GROUND UTILITY FEATURES AND BY USING PROFESSIONAL JUDGMENT IN CORRELATING THIS
 INFORMATION TO QUALITY LEVEL D INFORMATION. (SHOWN AS QLC)
- QUALITY LEVEL D (QLD): QUALITY LEVEL D IS THE LOWEST DEGREE OF ACCURACY. THE INFORMATION SHOWN ON THE PLANS WAS DERIVED SOLELY FROM EXISTING NYSDOT AND/OR UTILITY COMPANY RECORDS OR RECOLL FCTIONS. (SHOWN AS QLD)

SURVEY NOTES:

- BASE MAPPING INFORMATION PREPARED BY WESTON AND SAMPSON, LOCATED AT 1 WINNER'S CIRCLE, ALBANY, NY 12205 (Ph. 518-463-4400).
- RIGHT-OF-WAY INFORMATION PREPARED BY MJ ENGINEERING AND LAND SURVEYING, P.C. AND CREIGHTON MANNING ENGINEERING, LOCATED AT 1533 CRESCENT ROAD, CLIFTON PARK, NY 12065 (PH. 518-371-0799) AND 2 WINNER'S CIRCLE, ALBANY, NY 12205 (PH. 518-446-0396), RESPECTIVELY.
- 3. WETLAND DELINEATION INFORMATION PREPARED BY OSPA ENGINEERING SERVICES, P.C., LOCATED AT 800 ROUTE 146, BLDG. 200, SUITE 280, CLIFTON PARK, NY 12065 (Ph. 518-636-9956).

RIGHT OF WAY NOTES:

- 1. ALL WORK TO BE PERFORMED UNDER THIS CONTRACT WILL BE WITHIN THE PUBLIC RIGHT-OF-WAY (ROW). THE CONTRACTOR IS TO ASSURE THAT ALL WORK IS BEING PERFORMED WITHIN THE ROW, INCLUDING BUT NOT LIMITED TO VEHICLE ACCESS; STORAGE OF EQUIPMENT, MATERIALS, DEBRIS AND WASTE; LANDSCAPING; VEGETATION REMOVAL AND MANAGEMENT; GRADING, SEEDING AND THE INSTALLATION OF TURF; AND THE INSTALLATION OF ANY FENCES OR PROTECTIVE BARRIER.
- IF THE CONTRACTOR IS UNABLE TO IDENTIFY THE LIMITS OF THE RIGHTS-OF-WAY WHEN THE CONTRACT CALLS FOR WORK IN THOSE VICINITIES, THE CONTRACTOR MUST CONTACT THE PROJECT ENGINEER FOR DEFINITIVE BOUNDARY DETERMINATIONS BEFORE ANY WORK MAY BE INITIATED AT THOSE LOCATIONS.

ACCESS AND NOTIFICATION NOTES:

- THE CONTRACTOR TO PROVIDE SAFE AND ADEQUATE ACCESS INTO OR THROUGH THE WORK SITE BY EMERGENCY VEHICLES AT ALL TIMES.
- THE CONTRACTOR TO MAINTAIN ALL TRAFFIC IN ACCORDANCE WITH THE MANUAL ON UNIFORM
 TRAFFIC CONTROL DEVICES AND THE NYS SUPPLEMENT, AND EFFORTS SHALL BE COORDINATED WITH
 THE DIRECTOR'S REPRESENTATIVE, AND/OR THE APPLICABLE MUNICIPALITY, TEMPORARY PAVEMENT
 SHALL BE PLACED WITHIN 48 HOURS OF COMPLETION OF EXCAVATION AND BACKFILL OPERATIONS
 WITHIN THE PAVEMENT LIMITS.
- 3. THE CONTRACTOR TO NOTIFY THE STATE AND/OR APPLICABLE MUNICIPALITY 72 HOURS PRIOR TO ANY STREET OR LANE CLOSURES OR ANY WORK AFFECTING TRAFFIC SIGNALS.
- 4. THE CONTRACTOR TO MAINTAIN ACCESS TO ALL COMMERCIAL AND RESIDENTIAL PROPERTIES AT ALL TIMES TO THE SATISFACTION OF THE DIRECTOR'S REPRESENTATIVE. RAMPING CONSTRUCTION TO PROVIDE ACCESS MAY BE CONSTRUCTED WITH SUBBASE MATERIAL EXCEPT THAT TEMPORARY ASPHALT CONCRETE SHALL BE PLACED AS DIRECTED BY THE DIRECTOR'S REPRESENTATIVE. THE CONTRACTOR TO BE RESPONSIBLE FOR PROVIDING SAFE PEDESTRIAN ACCESS AT ALL TIMES.
- 5. THE CONTRACTOR TO NOTIFY ALL RESIDENTS AND BUSINESSES LOCATED IN THE WORK ZONE 72 HOURS PRIOR TO THE START OF CONSTRUCTION ACTIVITIES. SUCH NOTICES WILL BE FURNISHED BY THE CONTRACTOR AND APPROVED BY THE DIRECTOR'S REPRESENTATIVE AND/OR THE APPLICABLE MINICIPALITY.

REVISED DRAWING 4/30/2024

PROJECT SPECIFIC NOTES:

- THE CONTRACTOR TO NOT BEGIN WARMING UP HIS OR HER EQUIPMENT BEFORE 7:00 AM, NOR KEEP THE
 EQUIPMENT RUNNING AFTER 8:00 PM. MAINTENANCE OF EQUIPMENT ON SITE WHICH REQUIRES THE
 EQUIPMENT TO BE RUNNING SHALL BE APPROVED BY THE DIRECTOR'S REPRESENTATIVE IF THE
 MAINTENANCE IS PERFORMED OUTSIDE THE WORK HOUR RESTRICTIONS.
- ALL WORK WITHIN NYSDOT RIGHT-OF-WAY SHALL ADHERE TO NYSDOT STANDARD SPECIFICATIONS. THIS
 INCLUDES ALL MATERIAL SPECIFICATIONS AND WORK ZONE TRAFFIC CONTROL.
- CONTRACTOR TO RENT TWO UTILITY TERRAIN VEHICLES FOR THE DURATION OF THE PROJECT TO BE PROVIDED TO THE DIRECTOR'S REPRESENTATIVE. UTILITY TERRAIN VEHICLES SHALL BE CAPABLE OF TRANSPORTING TWO PASSENGERS EACH.
- CONTRACTOR TO PROVIDE FIELD OFFICE TRAILER. APPROXIMATE LOCATION SHOWN ON DWG. C-101, FINAL LOCATION TO BE CONFIRMED BY THE DIRECTOR'S REPRESENTATIVE.
- THIS PROJECT REQUIRED THE DEVELOPMENT OF A STORMWATER POLLUTION PREVENTION PLAN IN ACCORDANCE WITH NYSDEC SPDES GP-20-001. THE CONTRACTOR TO REFER TO PROJECT MANUAL FOR ADDITIONAL REQUIREMENTS AND SPECIFICATIONS.
- 7. CONTRACTOR IS RESPONSIBLE FOR ENSURING EXISTING CULVERT AND BRIDGE STRUCTURES HAVE THE CAPACITY TO CARRY THE CONTRACTOR'S CONSTRUCTION EQUIPMENT. IF CONTRACTOR DETERMINES STRENCTHENING IS NECESSARY TO ACCOMMODATE THEIR MEANS AND METHODS, HE OR SHE SHALL PROPOSE RETROFITS TO STRENCTHEN THE STRUCTURE. CONTRACTOR TO PHOTOGRAPH AND DOCUMENT THE CONDITION OF THE STRUCTURES PRIOR TO STARTING CONSTRUCTION. THIS SHALL BE DONE AS DIRECTED BY THE DIRECTOR'S REPRESENTATIVE AND BE PROVIDED TO THE DIRECTOR'S REPRESENTATIVE AND BE PROVIDED TO THE DIRECTOR'S REPRESENTATIVE FOR RECORD KEEPING. ALL COSTS FOR THIS WORK SHALL BE INCLUDED IN THE LUMP SUM BID FOR THIS PROJECT AND ANY DAMAGE RESULTING FROM THE CONTRACTOR'S ACTIONS SHALL BE REPAIRED AT NO
- CONTRACTOR TO INSTALL TEMPORARY GATES AT ALL PUBLIC ROADWAY ACCESS POINTS AND SNOW FENCE AT PRIVATE ACCESS POINTS TO PREVENT PUBLIC ACCESS DURING CONSTRUCTION COORDINATED WITH THE DIRECTOR'S REPRESENATIVE FOR LOCATIONS.
- ALL INVASIVE SPECIES REMOVAL LOCATIONS TO BE FLAGGED AND APPROVED BY DIRECTORS
 REPRESENTATIVE. CONTRACTOR TO REMOVE AND DISPOSE OF INVASIVE SPECIES AND CLEAN ALL
 EQUIPMENT INVOLVED IN OPERATIONS.
- 10. SEE PROJECT MANUAL FOR WETLAND PERMITS AND REQUIRED SCHEDULING PRIOR TO BEGINNING WORK.
- 11. CONTRACTOR TO NOTE THAT THIS CONTRACT ALSO INCLUDES:
 - A. THE REPLACEMENT OF A PAIR OF EXISTING 36" CMP PIPES WITH A CONCRETE STRUCTURE IN THE VILLAGE OF SARANAC LAKE, SEE DWG, S-401 THROUGH S-502. CULVERT REPLACEMENT WORK MAY NOT BEGIN PRIOR TO MAY 1, 2025 AND TO BE COMPLETED PRIOR TO JUNE 15, 2025.
 - B. INSTALLATION OF 100 WHITE SPRUCE TREES, 7'-8' TALL, ALONG THE NORTHEAST SIDE OF THE TRAIL IN THE VILLAGE OF SARANAC LAKE ALONG THE MCKENZIE BROOK. TREES TO BE PLANTED 10' APART, LOCATIONS TO BE MARKED OUT BY DIRECTOR'S REPRESENTATIVE.
 - C. INSTALLATION OF A LARGER TRAIL GATE ON RAY BROOK ROAD IN RAY BROOK. LOCATION LISTED IN TABLE OF TRAIL GATES ON DWG. C-602 AND DIMENSION NOTED IN NOTES ON GATE DETAIL ON DWG. C-502.
 - D. INSTALLATION OF ADDRESS SIGNS AT LOCATIONS IN LAKE CLEAR, RAY BROOK, SARANAC LAKE, AND TUPPER LAKE, LOCATIONS AND SIGN DETAILS SHOWN ON DWG. C-501.
 - INSTALLATION OF BEAVER DETERRENT DEVICES ON INLET END OF 26 EXISTING CULVERTS LISTED IN TABLE ON DWG. C-601 AND AS DETAILED ON C-505. CONTRACTOR TO REPAIR ANY AREAS OF TRAIL SURFACE COURSE OR AREAS ALONG TRAIL EDGE THAT ARE DAMAGED DURING THE INSTALLATION OF THE DEVICES. THE EXISTING PIPES WERE CLEAR AND FLOWING DURING A FIELD WALK COMPLETED IN SEPTEMBER 2023. CONTRACTOR TO VERIFY EXISTING CULVERTS ARE CLEAR OF ANY DEBRIS PRIOR TO INSTALLATION OF BEAVER DETERRENT DEVICE. IF ANY DEBRIS IS PRESENT, CONTRACTOR TO COORDINATE WITH THE DIRECTOR'S REPRESENTATIVE AND DETERMINE THE APPROPRIATE METHOD FOR REMOVAL OF THE DEBRIS TO MINIMIZE ANY IMPACTS TO SURROUNDING WETLANDS. COST OF DEBRIS REMOVAL TO BE INCLUDED IN LUMP SUM BID PRICE FOR PROJECT
 - F. FURNISHING 5 SECTIONS OF 1¾" DIAMETER DRILL ROD AND 2 END PIECES TO BE AVAILABLE ON SITE IF NEEDED FOR CLEARING CULVERTS AND TO BE TURNED OVER TO NYSDEC AT END OF CONTRACT.
 - INSTALLATION OF ADDITIONAL GUSSET PLATE, YELLOW REFLECTIVE TAPE, AND DRILLING OF ADDITIONAL HOLE IN GATE POSTS SO GATE CAN BE PINNED AT 90 DEGREE INCREMENTS. TRAIL GATES REQUIRING GUSSET PLATES, YELLOW REFLECTIVE TAPE, AND MODIFICATIONS ARE LISTED IN TABLE OF GUSSET PLATES AND GATE MODIFICATIONS ON DWG. C-601. DETAIL OF GUSSET PLATE AND YELLOW REFLECTIVE TAPE ARE DETAILED ON DWG. C-502
- H. INSTALLATION OF OBJECT MARKER SIGN PANELS ON BEGINNING AND END POSTS OF ALL SECTIONS OF PEDESTRIAN TIMBER RAIL BETWEEN TUPPER LAKE AND LAKE PLACID. SEE TABLE OF LOCATIONS ON DWG. C-602 AND SIGN PANEL DETAILS ON DWG. C-501.
- REMOVAL OF ANY BLOW DOWN OR FALLEN TREES WITHIN THE SITE CLEARING LIMITS, LIMITS OF GRADING, OR
 AS DIRECTED BY DIRECTOR'S REPRESENTATIVE. SITE CONDITIONS MAY HAVE CHANGED DUE TO STORMS THAT
 HAVE OCCURRED SINCE THE FIELD CHECK WAS COMPLETED IN SEPTEMBER 2023.
- J. REMOVAL OF ALL DAMAGED OR DETERIORATED WHISTLE STOP AND MILE POST MARKERS AS DIRECTED BY THE DIRECTOR'S REPRESENTATIVE.
- K. THE REMOVAL OF ANY TRAIL SIDE HAZARDS THAT MAY BE PRESENT, THESE INCLUDE: LARGE ROCKS WITHIN 5 FEET OF THE EDGE OF THE TRAIL, OLD PIECES OF CONCRETE ALONG THE CORRIDOR, AND ANY STEEL POSTS OR RAIL PIECES DRIVEN IN THE GROUND, ROCKS ARE TO BE MOVED SO THEY ARE MORE THAN 5 FEET FROM EDGE OF TRAIL, CONCRETE IS TO BE REMOVED FROM TRAIL CORRIDOR, AND STEEL POSTS OR RAIL PIECES ARE TO BE DRIVEN SO THEY ARE AT OR BELOW GRADE OR CUT FLUSH WITH EXISTING GRADE IF THEY CAN NOT BE DRIVEN.
- L. INSTALLATION OF 20 DELINEATORS WITH 2.0 LB POSTS. 10 DELINEATORS TO BE INSTALLED IN TUPPER LAKE PARKING LOT TO DELINEATE EDGES OF GRASS ISLANDS NEAR PARKING LOT EXIT, 5 DELINEATORS TO BE INSTALLED ON NORTH AND SOUTH SIDE OF ROUTE 86 AT THE FOWLERS CROSSING PARKING LOTS IN RAY BROOK TO DELINEATE EDGE OF DRIVEWAYS.
- M. INSTALL EPOXY STRIPING ON 11 EXISTING CROSSWALKS CROSSING; CEDAR STREET, DEPOT STREET, MARGARET STREET, PINE STREET, BRANDY BROOK AVENUE, NCCC DRIVEWAY, ADIRONDACK CORRECTIONAL MAIN ROAD, ADIRONDACK PARK ROAD, OLD MILITARY ROAD, AND STATION STREET IN THE VILLAGES OF SARANAC LAKE AND LAKE PLACED.
- N. REPLACING EXISTING 24" CAST IRON PIPE AT N: 1992265,8550, E: 594074,3410 WITH A 30" SICPP PIPE, SEE DWG. G-006 FOR LOCATION AND DWG. C-506 FOR INSTALLATION DETAIL.
- O. EXCAVATE EXISTING TRAIL, INSTALL 6" THICK FOAM INSULATION BOARD, INSTALL SUBBASE, AND PAVE 50 FOOT LONG SECTION OF TRAIL AS DETAILED ON DWG. C-507, OVER EXISTING STEAM TUNNEL NEAR CONCRETE RAMP LOCATED AT N: 1989683.2694, E: 598814.5157 AND AND SHOWN ON DWG. G-006.



Creighton Manning

WARNING:

THE ALTERATION OF THIS MATERIAL IN ANY WAY, UNLESS DONE UNDER THE DIRECTION OF A COMPARABLE PROFESSIONAL, ILE ARCHITECT FOR AN ARCHITECT, ENGINEER FOR AN ENGINEER OR LANDSCAPE ARCHITECT, IS A VIOLATION OF THE NEW YORK STATE EDUCATION LAW ANDIOR REGULATION AND IS A CLASS "A WISDEMENON."



CONSTRUCTION

PROVIDE RECREATIONAL
MULTI-USE RAIL TRAIL
FLOODWOOD TO TUPPER LAKE

CATION:

FLOODWOOD TO TUPPER LAKE


CLIENT:
NYS DEPARTMENT OF
ENVIRONMENTAL CONSERVATION

043024 ADDENDUM#1
021524 BID DOCUMENTS
MARK DATE DESCRIPTION
PROJECT
NUMBER: 47602-C

GENERAL NOTES

G-004

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WARNING:

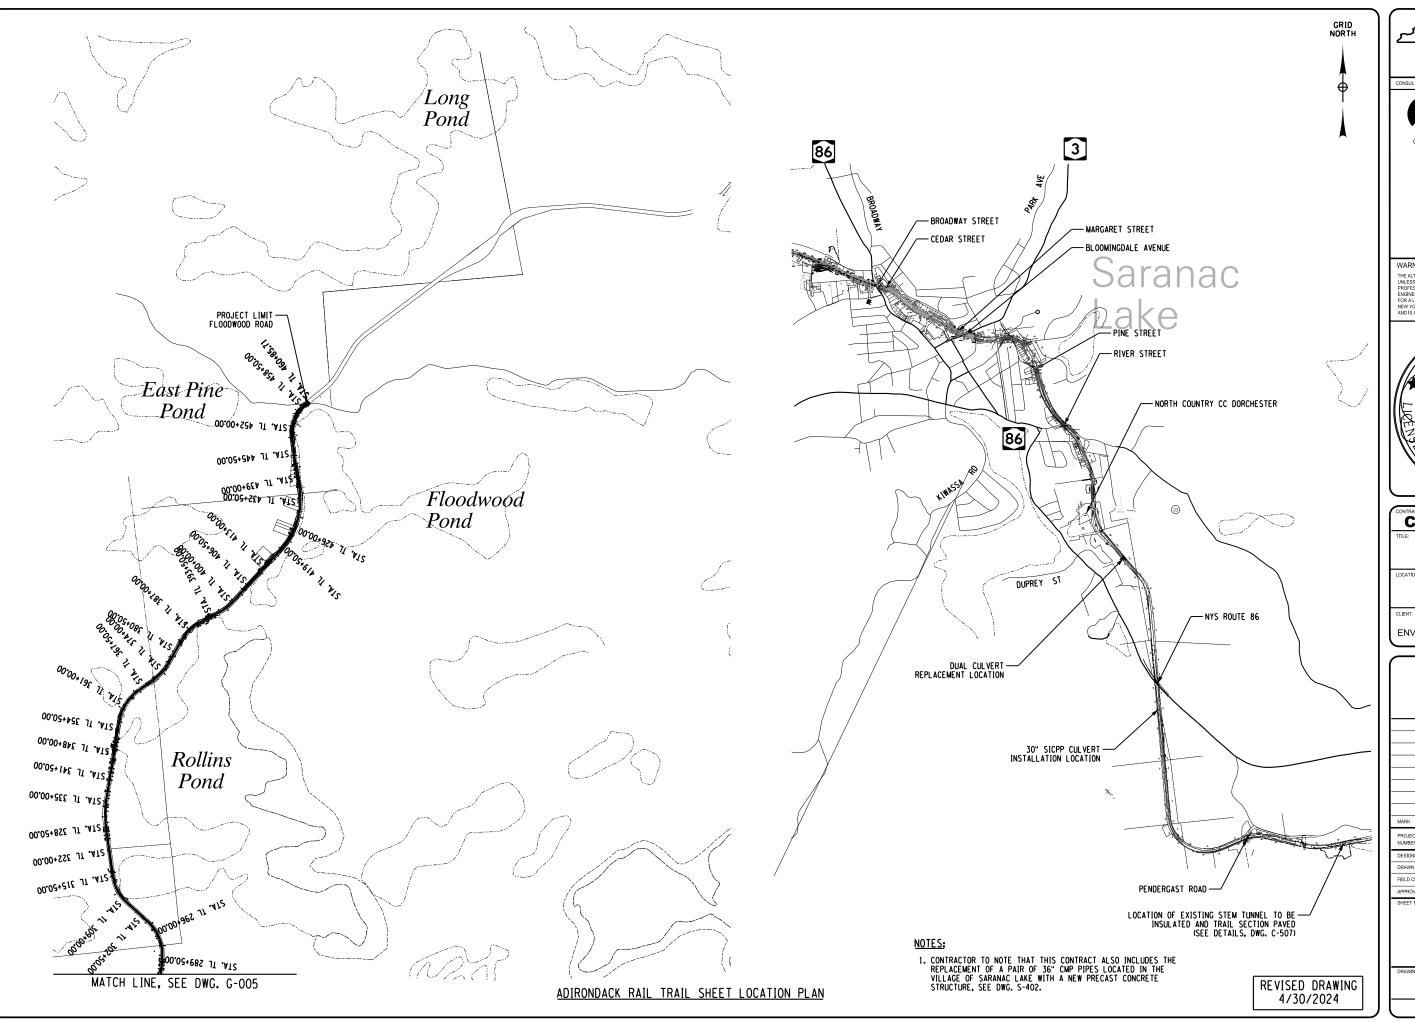

CONSTRUCTION

PROVIDE RECREATIONAL MULTI-USE RAIL TRAIL FLOODWOOD TO TUPPER LAKE

FLOODWOOD TO TUPPER LAKE

NYS DEPARTMENT OF
ENVIRONMENTAL CONSERVATION


	04/30/24	ADDENDUM #1
	02/15/24	BID DOCUMENTS
К	DATE	DESCRIPTION
JECT BER:	47	602-C
GNED BY:	C	D.F.

DESIGNED BY:	C.D.F.
DRAWN BY:	K.H.D.
FIELD CHECK:	09/12/2023
APPROVED:	D.D.A.
SHEET TITLE	

SITE KEY PLAN

G-006


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INSTALLATION OF PROPOSED DRAINAGE PIPE (NOT TO SCALE)

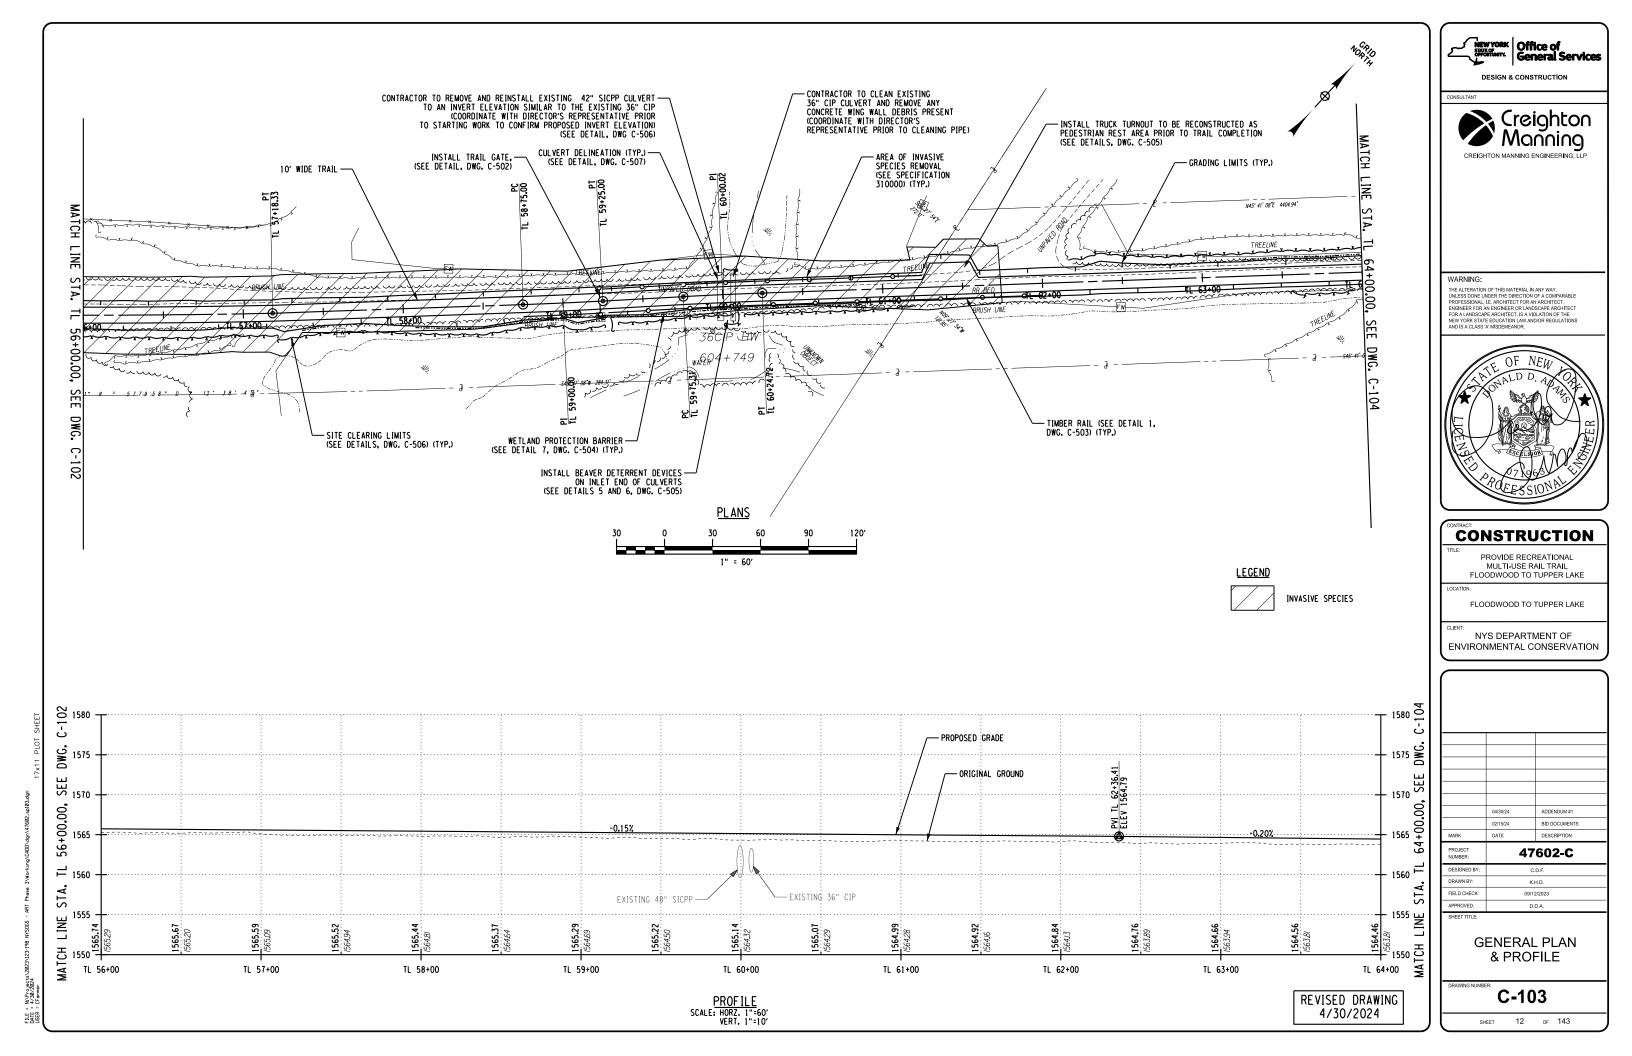
NOTES:

- DEPTH OF EXISTING ASPHALT AT DUAL CULVERT REPLACEMENT LOCATION IS 1½" NYS TYPE 7 9.5MM ASPHALT TOP COURSE AND 2½" TYPE 3 19MM ASPHALT PUNISE CUIPSE
- FOR 42" SICPP CULVERT REINSTALLATION AT STA. TL 60+00 AND 30" SICPP CULVERT INSTALLATION IN SARANAC LAKE, INSTALL 3" TRAIL TOP COURSE MATERIAL AND 6" OF SUBBASE.



SITE CLEARING NOTES:

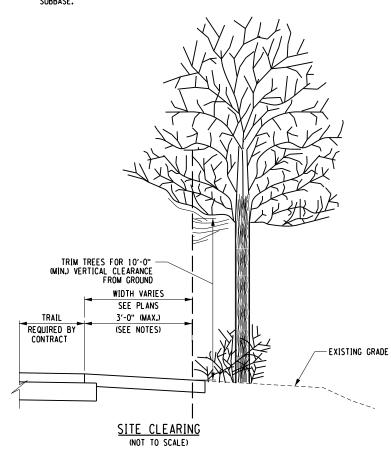
- 1. FOR TOTAL LENGTH OF TRAIL CONTRACTOR SHALL PERFORM SITE CLEARING FROM EDGE OF TRAIL A MAXIMUM OF 3'-O" OR TO THE TOP OF THE SLOPE BREAK WHICHEVER OCCURS FIRST TO A 10'-O" VERTICAL CLEARANCE. CONTRACTOR IS REQUIRED TO CUI LIMBS AT THE BRANCH BASE. ANY EXISTING TREES NOT INDICATED ON THE PLACE FOR REMOVAL AND ARE 4" DIA OR LARGER WITHIN THE 3'-O" CLEAR AREA SHALL BE TAGGED. APPROVAL FOR THE REMOVAL OF TAGGED TREES SHALL BE GIVEN BY THE DIRECTORS REPRESENTATIVE.
- FOR SPECIFIC LOCATIONS NOTED ON TRAIL GENERAL PLANS FOR SITE CLEARING, THE 3'-O" MAXIMUM DOES NOT APPLY IN THESE LOCATIONS, CONTRACTOR SHALL PERFORM SITE CLEARING TO THE GRADING LIMITS SHOWN.

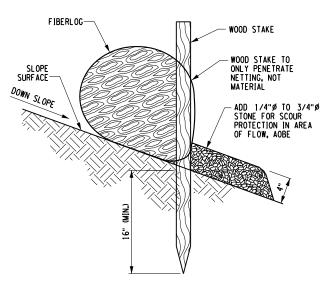

FIBER LOG STAKE DETAIL (ON BARE SOIL)


FIBER LOG CHECK DAM APPLICATION NOTES:

- A. THE PRIMARY PURPOSE OF A CHECK DAM IS TO REDUCE EROSION IN A CHANNEL BY REDUCING FLOW VELOCITY IN
- B. CHECK DAMS WILL CAPTURE SEDIMENT THAT FALLS OUT OF SUSPENSION BEHIND THE CHECK DAM DUE TO DECREASED VELOCITY.
- C. CHECK DAMS ARE NOT INTENDED TO, AND WILL NOT FILTER SEDIMENT FROM TURBID WATER.

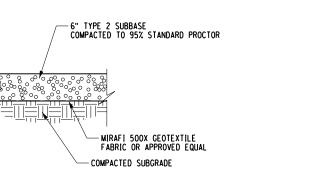

ROADWAY APRON DETAIL (NOT TO SCALE)


1. CROSSED GRAVEL DRIVEWAY APRONS

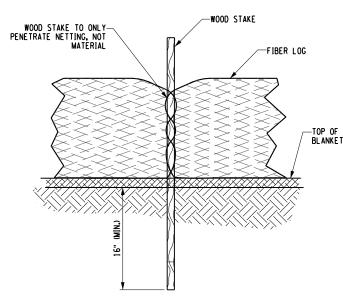

FIBER LOG STAKE DETAIL (FRONT VIEW) (NOT TO SCALE)

NOTES:

- 1. DRAINAGE AREAS: MAXIMUM DRAINAGE AREA TRIBUTARY TO FIBER LOG CHECK DAM SHALL BE LACRE. MAXIMUM DRAINAGE AREA TRIBUTARY TO PREFABRICATED CHECK DAM SHALL BE 1/2 ACRE.
- POSTS MAY BE 1½" x 1¼" (MIN.) HARDWOOD, 1½" x 3½" (MIN.) SOFTWOOD. ADDITIONAL POSTS ARE REQUIRED AT THE OUTER EDGES OF DITCH WIDTH.
- 3. THE FIBER LOG SHALL BE INSTALLED WITH THE POSTS ON THE DOWNSTREAM SIDE OF THE FABRIC AS SHOWN.
- 4. SEDIMENT SHALL BE REMOVED WHEN ACCUMULATION REACHES ONE-HALF OF THE MEASURE HEIGHT OF THE FIBER LOG, SEDIMENT SHALL BE DISPOSED OF AS UNSUITABLE MATERIAL.

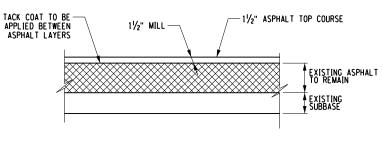

TUPPER LAKE PARKING LOT MILL AND FILL

NOTE:

1. CONTRACTOR TO MATCH EXISTING ASPHALT TOP COURSE, 1½" NYS TYPE 7 9.5mm ASPHALT TOP COURSE

REVISED DRAWING 4/30/2024



DESIGN & CONSTRUCTION



WARNING:

THE ALTERATION OF THIS MATERIAL IN ANY WAY, UNLESS DONE UNDER THE DIRECTION OF COMPARABLE PROFESSIONAL, LE, ARCHITECT FOR AN ARCHITECT, EMBINEER FOR AN ENGINEER OR LANDSCAPE ARCHITECT, SOFT A LANDSCAPE ARCHITECT, IS A VIOLATION OF THE NEW YORK STATE EDUCATION LAW ANDOR REGULATIONS AND IS A CLASS AT MISBEMENANCE.



CONSTRUCTION

PROVIDE RECREATIONAL MULTI-USE RAIL TRAIL FLOODWOOD TO TUPPER LAKE

FLOODWOOD TO TUPPER LAKE

NYS DEPARTMENT OF **ENVIRONMENTAL CONSERVATION**

04/30/24 ADDENDUM #1 DESCRIPTION 47602-C


DRAWN BY: K.H.D. FIELD CHECK APPROVED: D.D.A.

MISCELLANEOUS DETAILS

C-506


122 of 143

REFER TO SPECIFICATIONS 310000, 311000, 312513, 320117, 334104

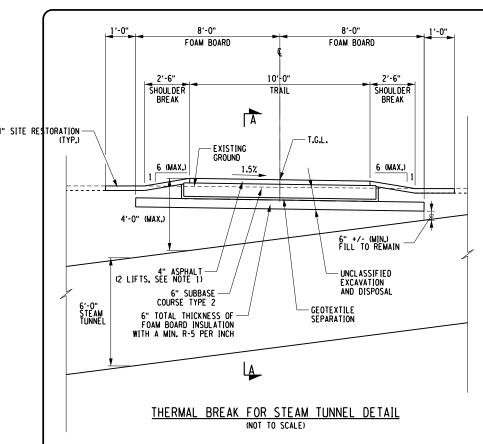

NOTE:

 ASPHALT TRAIL SECTION LIFTS TO INCLUDE 1.5" NYS TYPE 7 9.5MM ASPHALT TOP COURSE ADN 2.5" NYS TYPE 3 19MM ASPHALT BINDER COURSE

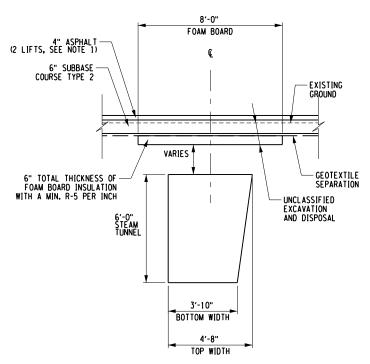



THERMAL BREAK FOR STEAM TUNNEL DETAIL SECTION A-A

NOTE

 ASPHALT TRAIL SECTION LIFTS TO INCLUDE 1.5" NYS TYPE 7 9.5MM ASPHALT TOP COURSE ADN 2.5" NYS TYPE 3 19MM ASPHALT BINDER COURSE

REFER TO SPECIFICATIONS 015813, 310101, 321216, 334113

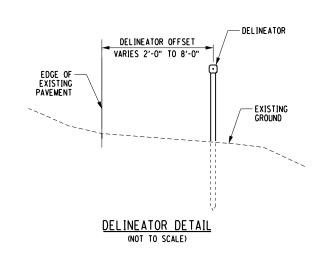


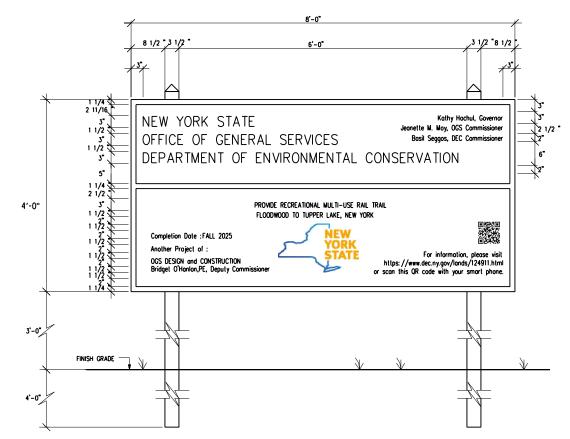

PROJECT IDENTIFICATION SIGN DETAIL


NOTES

- 1. CONTRACTOR TO REFER TO DIRECTOR'S REPRESENTATIVE FOR SIGN TEXT.
- 2. CONTRACTOR TO REFERENCE SPECIFICATION 015813 IN CONTRACT DOCUMENTS FOR ADDITIONAL DETAILS.
- 3. TWO PROJECT IDENTIFICATION SIGNS ARE INCLUDED IN THIS PROJECT. EXACT LOCATION TO BE DETERMINED BY DIRECTOR'S REPRESENTATIVE.

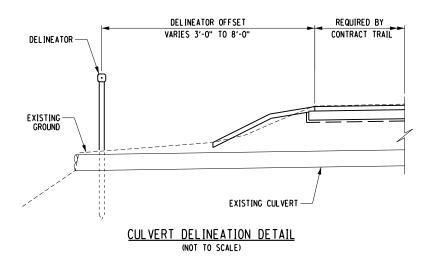

CULVERT DELINEATION NOTES:

- 1. WORK SHALL CONSIST OF INSTALLING A DELINEATOR AT EXISTING CULVERT LOCATION.
- 2. DELINEATOR OFFSET FROM THE EDGE OF THE TRAIL SHALL BE DETERMINED ON A CASE BY CASE SCENARIO BY THE DIRECTOR'S REPRESENTATIVE.
- 3. DIRECTOR'S REPRESENTATIVE SHALL DETERMINE WHICH SIDE OF THE TRAIL THE DELINEATOR WILL BE INSTALLED ON A CASE BY CASE SCENARIO.
- 4. EXISTING CULVERT NOTED TO HAVE DELINEATORS INSTALLED IN THE CULVERT DELINEATION TABLE THAT ARE NOT CALLED OUT OR IDENTIFIED ON THE GENERAL PLAN AND PROFILE SHEETS SHALL HAVE THEIR LOCATIONS VERIFIED IN THE FIELD BY THE DIRECTOR'S REPRESENTATIVE.

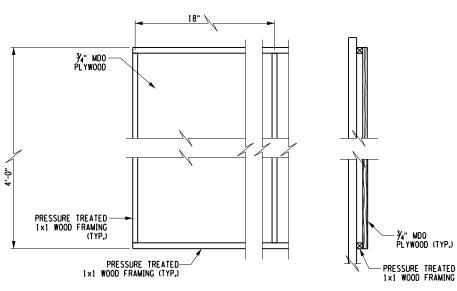

PARTIAL REAR ELEVATION DETAIL
(NOT TO SCALE)

SECTION DETAIL
(NOT TO SCALE)

REVISED DRAWING 4/30/2024



DESIGN & CONSTRUCTION



WARNING:

UNLESS DONE UNDER THE DIRECTION OF A COMPARABLE PROFESSIONAL, I.E. ARCHITECT FOR AN ARCHITECT, ENGINEER FOR AN ENGINEER OR LANDSCAPE ARCHITECT FOR A LANDSCAPE ARCHITECT, IS A VIOLATION OF THE NEW YORK STATE EDUCATION LAW AND/OR REGULATIONS AND IS A CLASS 'A MISCEMEANOR.



CONSTRUCTION

PROVIDE RECREATIONAL MULTI-USE RAIL TRAIL FLOODWOOD TO TUPPER LAKE

LOCATION:

FLOODWOOD TO TUPPER LAKE

CLIENT:
NYS DEPARTMENT OF
ENVIRONMENTAL CONSERVATION

04/30/24 ADDENDUM#1
02/15/24 BID DOCUMENTS
MARK DATE DESCRIPTION
PROJECT
ULMBER: 47602-C
DESIGNED BY: C.D.F.

DESIGNED BY: C.D.F.

DRAWN BY: K.H.D.

FIELD CHECK: 08/12/2023

APPROVED: D.D.A.

MISCELLANEOUS DETAILS

C-507

т 123 оғ 143

	PLOT SHEET
	17×11
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NYSOGS	
J\Projects\2023\123-198 !	
₫"	

TABLE OF TIMBER RAIL					
STA	TION	CIDE	LENCTH		
FROM	T0	SIDE	LENGTH		
TL 58+75.00	TL 62+00.00	RT	325		
TL 59+25.00	TL 61+25.00	LT	200		
TL 83+25.00	TL 84+75.00	RT	150		
TL 83+25.00	TL 84+75.00	LT	150		
TL 123+75.00	TL 125+00.00	RT	125		
TL 123+75.00	TL 125+00.00	LT	125		
TL 161+25.00	TL 162+50.00	RT	125		
TL 205+50.00	TL 208+75.00	RT	325		
TL 207+00.00	TL 210+00.00	LT	300		
TL 225+25.00	TL 230+25.00	LT	500		
TL 227+00.00	TL 231+00.00	RT	400		
TL 233+25.00	TL 234+00.00	RT	75		
TL 256+75.00	TL 259+00.00	RT	225		
TL 266+50.00	TL 269+25.00	LT	275		
TL 267+00.00	TL 269+50.00	RT	250		
TL 271+75.00	TL 280+25.00	LT	850		
TL 271+75.00	TL 280+00.00	RT	825		
TL 280+25.00	TL 289+50.00	LT	825		
TL 280+50.00	TL 289+00.00	RT	850		
TL 308+50.00	TL 314+25.00	LT	575		
TL 308+50.00	TL 320+75.00	RT	1225		
TL 314+50.00	TL 320+00.00	LT	550		
TL 337+50.00	TL 347+00.00	LT	950		
TL 337+50.00	TL 351+25.00	RT	1375		
TL 348+00.00	TL 354+50.00	LT	650		
TL 354+00.00	TL 358+25.00	RT	425		
TL 376+50.00	TL 383+50.00	LT	700		
TL 376+50.00	TL 383+50.00	RT	700		
TL 391+25.00	TL 395+50.00	RT	425		
TL 405+00.00	TL 414+75.00	LT	975		
TL 405+00.00	TL 414+75.00	RT	975		
TL 414+80.00	TL 415+25.00	LT	45		
TL 414+80.00	TL 415+25.00	RT	45		
TL 420+25.00	TL 424+97.00	RT	472		
TL 425+05.00	TL 425+79.00	RT	74		
TL 425+87.00	TL 426+58.00	RT	71		
TL 426+66.00	TL 426+75.00	RT	9		
TL 437+50.00	TL 439+90.00	RT	240		
TL 439+98.00	TL 442+03.00	RT	205		
TL 443+11.00	TL 444+50.00	RT	139		
TL 441+50.00	TL 450+50.00	LT	870		
TL 451+00.00	TL 454+50.00	RT	350		
TL 451+50.00	TL 454+25.00	LT	275		
TL 457+25.00	TL 460+45.00	RT	320		
TL 458+00.00	TL 459+50.00	LT	150		
AS ORDERED BY	DIRECTOR'S REPRESI	NTATIVE	310		

TABLE OF TIMBER GUIDE RAIL					
STA	TION	CIDE	LENGTH		
FROM	TO	SIDE	LENGTH		
TL 32+29	TL 32+33	RT	24		
TL 32+40	TL 32+42	RT	10		
TL 35+00	TL 35+20	RT	20		
TL 35+66	TL 35+86	RT	20		
TL 37+97	TL 38+45	RT	48		
TL 39+50	TL 39+90	RT	48		
TL 40+09	TL 40+23	RT	16		
TL 42+75	TL 42+88	LT	12		
TL 43+17	TL 43+27	LT	12		
TL 43+50	TL 43+50	LT	10		
TL 43+50	TL 43+50	RT	12		
TL 171+75	TL 171+75	LT	8		
TL 171+75	TL 171+75	RT	16		
TL 172+75	TL 172+75	LT	8		
TL 172+75	TL 172+75	RT	12		
TL 358+00	TL 358+00	LT	10		
TL 358+00	TL 358+00	RT	12		
TL 436+00	TL 436+00	LT	12		
TL 436+00	TL 436+00	RT	8		
TL 460+50	TL 460+50	LT	8		
AS ORDERED BY	DIRECTOR'S REP	RESENTATIVE	40		
AND ORDERED BY DIRECTOR'S REPRESENTATIVE					

TABLE OF WETLAND PROTECTION BARRIER

CTATION .				
STATION TO		SIDE	LENGTH	
TL 57+35.00	TL 57+50.00	RT	15	
TL 58+07.00	TL 60+87.00	RT	280	
TL 67+35.00	TL 68+45.00	RT	10	
TL 68+55.00	TL 68+95.00	RT	40	
TL 69+75.00	TL 70+90.00	RT	115	
TL 77+85.00	TL 78+70.00	RT	85	
TL 79+65.00	TL 79+85.00	RT	20	
TL 80+55.00	TL 81+15.00	RT	60	
TL 82+90.00	TL 84+50.00	RT	160	
TL 86+70.00	TL 89+15.00	RT	245	
TL 90+35.00	TL 92+65.00	RT	230	
TL 94+25.00	TL 95+65.00	RT	140	
TL 96+00.00	TL 96+20.00	RT	20	
TL 104+00.00	TL 104+25.00	RT	25	
TL 105+46.00	TL 105+96.00	RT	50	
TL 122+47.00	TL 124+62.00	RT	215	
TL 125+13.00	TL 126+98.00	RT	185	
TL 127+08.00	TL 127+33.00	RT	25	
TL 127+67.00	TL 129+07.00	RT	140	
TL 134+00.00	TL 134+65.00	RT	65	
TL 183+91.00	TL 184+11.00	RT	20	
TL 207+56.00	TL 208+01.00	RT	45	
TL 223+46.00	TL 223+91.00	RT	45	
TL 254+55.00	TL 257+70.00	RT	315	
TL 257+95.00	TL 258+55.00	RT	60	
TL 292+97.00	TL 293+47.00	RT	50	
TL 326+40.00	TL 330+00.00	RT	360	
TL 333+71.00	TL 335+31.00	RT	160	
TL 341+39.00	TL 341+59.00	RT	20	
TL 376+00.00	TL 383+80.00	RT	780	

BARRIER				
STATION		LENGTH		
T0	JIDE			
TL 64+35.00	LT	110		
TL 86+45.00	LT	20		
TL 87+94.00	LT	55		
TL 89+29.00	LT	30		
TL 106+59.00	LT	30		
TL 109+77.00	LT	30		
TL 126+80.00	LT	380		
TL 132+58.00	LT	15		
TL 148+75.00	LT	25		
TL 177+61.00	LT	250		
TL 183+89.00	LT	155		
TL 184+82.00	LT	70		
TL 185+30.00	LT	10		
TL 187+32.00	LT	10		
TL 191+30.00	LT	350		
TL 198+18.00	LT	580		
TL 206+98.00	LT	20		
TL 212+94.00	LT	25		
TL 228+70.00	LT	60		
TL 256+30.00	LT	10		
TL 268+00.00	LT	35		
TL 268+87.00	LT	40		
TL 330+59.00	LT	435		
TL 331+26.00	LT	40		
TL 334+54.00	LT	10		
TL 336+67.00	LT	90		
	TION TO TL 64+35.00 TL 86+45.00 TL 87+94.00 TL 89+29.00 TL 109+77.00 TL 126+80.00 TL 132+58.00 TL 148+75.00 TL 177+61.00 TL 184+82.00 TL 185+30.00 TL 181+32.00 TL 198+18.00 TL 198+18.00 TL 122+94.00 TL 228+70.00 TL 228+70.00 TL 268+87.00 TL 268+87.00 TL 268+87.00 TL 331+54.00 TL 331+54.00 TL 331+54.00 TL 331+54.00	TION TO TL 64+35.00 TL 86+45.00 TL 87+94.00 TL 87+94.00 TL 187+94.00 TL 109+77.00 TL 109+77.00 TL 126+80.00 TL 132+58.00 TL 148+75.00 TL 148+75.00 TL 17+61.00 TL 184+82.00 TL 184+82.00 TL 187+32.00 TL 187+32.00 TL 191+30.00 TL 191+30.00 TL 191+30.00 TL 206+98.00 TL 212+94.00 TL 228+70.00 TL 228+70.00 TL 268+87.00 TL 268+87.00 TL 268+87.00 TL 331+26.00 TL 334+54.00		

TABLE OF WETLAND PROTECTION

TABLE OF GU	SSET PLATES
AND GATE M	ODIFICATIONS
NORTHING	EASTING
2004232.1904	586610.2149
2004204.4422	586700.4157
2004162.3478	586845.8519
2004146.1296	586905.6877
2003403.4832	587986.3649
2003380.5700	588029.4770
2003037.0369	588676.2897
2002992.0459	588781.7224
2002957.8566	588898.7338
2002921.7019	588965.7674
2002848.2482	590100.0962
2002836.4052	590170.8696
2002086.1939	590767.6655
2002003.2687	590788.7837
2000601.0456	591487.3436
2000557.1958	591532.7772
1999027.5636	592273.8156
1998971.4643	592277.4555
1993865.7914	593965.9518
1993824.2066	593926.0139
1989838.7106	596275.9380
1989854.2560	569323.9124
1989637.5327	597735.2509
1989624.5156	597801.0211
1989682.6800	598811.4265
1989693.6772	598869.0665
1990251.1025	600471.2275
1989907.5106	604795.7808
1989898.9364	604822.7764
1984070.8150	623069.2235
1984078.3424	623124.4265
1983335.0837	625537.4541

TABLE OF	BEAVER DETERRENT	DEVICES
LOC	ATION	DEVICE DETAIL
	50+00	DWG. C-505, DETAIL 6
TL	50+05	DWG. C-505, DETAIL 5
TL	34+02	DWG. C-505, DETAIL 6
TL	34+06	DWG. C-505, DETAIL 6
TL 2	05+21	DWG. C-505, DETAIL 5
TL 2	28+60	DWG. C-505, DETAIL 6
TL 2	85+80	DWG. C-505, DETAIL 6
TL 3	49+80	DWG. C-505, DETAIL 6
TL 3	94+70	DWG. C-505, DETAIL 6
NORTHING	EASTING	
2006871.3087	517637.0645	DWG. C-505, DETAIL 5
2011087.0543	522421.0054	DWG. C-505, DETAIL 5
2010488.2140	521809.0448	DWG. C-505, DETAIL 5
2013503.9537	535276.3017	DWG. C-505, DETAIL 5
2013356.3530	535901.5489	DWG. C-505. DETAIL 5
2013133.4797	538370.5906	DWG. C-505, DETAIL 5
2010588.4904	568078.7612	DWG. C-505, DETAIL 5
2009535.7690	576231.2637	DWG. C-505, DETAIL 5
1993183.3227	593988.6306	DWG. C-505, DETAIL 5
1992267.7199	594074.4967	DWG. C-505, DETAIL 5
1991972.8592	594101.9959	DWG. C-505, DETAIL 5
1991536.4191	594142.6644	DWG. C-505, DETAIL 5
1990462.8989	603818.0512	DWG. C-505, DETAIL 6
1989473.6951	606416.9641	DWG. C-505, DETAIL 5
1988422.5248	607434.4502	DWG. C-505, DETAIL 5
1987964.8953	607888.8953	DWG. C-505, DETAIL 5
1987731.9161	608119.7336	DWG. C-505, DETAIL 5
1983442.4071	619503.6407	DWG. C-505, DETAIL 5

TABLE (OF SITE CL	EARING LIMITS	
STA FROM	STATION TO		AREA (SF)
	_	0.7	0000
TL 55+33	TL 61+20	RT · •	2608
TL 60+04	TL 60+11	LT	18
TL 62+18	TL 67+71	LT	2497
TL 63+55	TL 63+95	RT	79
TL 67+00	TL 70+49	RT	1234
TL 71+75	TL 73+00	RT	475
TL 76+39	TL 77+09	LT	148
TL 82+06	TL 84+77	LT	645
TL 83+97	TL 84+10	RT · •	80
TL 85+56	TL 91+02	LT	3551
TL 86+86	TL 87+68	RT	137
TL 90+50	TL 97+14	RT	2706
TL 97+96	TL 98+78	RT	473
TL 99+00	TL 99+90	RT	755
TL 100+93	TL 104+87	RT	2022
TL 102+46	TL 104+55	LT	715
TL 105+72	TL 106+77	RT	245
TL 106+92	TL 107+71	RT	184
TL 108+00	TL 116+45	RT	2599
TL 117+56	TL 118+35	RT	125
TL 118+03	TL 118+20	LT	79
TL 120+76	TL 125+57	LT	1268
TL 121+60	TL 127+47	RT	2031
TL 126+00	TL 132+80	LT	1293
TL 128+70	TL 136+00	RT	3413
TL 133+67	TL 134+82	LT	248
TL 139+16	TL 139+75	LT	102
TL 143+70	TL 144+78	RT	299
TL 144+06	TL 145+22	LT	241
TL 148+92	TL 149+41	RT	121
TL 149+00	TL 149+07	LT	2
TL 160+50	TL 160+83	RT	84
TL 162+37	TL 162+71	LT	56
TL 171+96	TL 172+18	RT	218
TL 174+90	TL 177+13	LT	450
TL 176+28	TL 177+22	RT	127
TL 177+60	TL 197+67	LT	9924
TL 180+62	TL 183+19	RT	351
TL 183+85	TL 184+23	RT	93
TL 189+65	TL 190+75	RT	426
TL 197+83	TL 199+27	RT	560
TL 199+78	TL 210+70	LT	5046
TL 207+50	TL 208+23	RT	151
TL 212+45	TL 215+12	LT	1159
TL 218+75	TL 219+61	LT	339
TI 222+00	TI 223+12	l it	294

TL 222+00 TL 223+12 LT
TL 222+62 TL 223+10 RT

TL 223+32 TL 223+90 RT

TL 223+68 TL 227+39 LT 1566
TL 226+98 TL 231+04 RT 1658

FROM TO SIDE AREA (SF) TL 249+17 TL 249+80 LT 330 TL 253+00 TL 259+40 RT 2550 TL 255+00 TL 259+29 LT 1094 TL 266+90 TL 267+46 LT 154 TL 268+15 TL 268+92 LT 319 TL 268+86 TL 268+94 RT 27 TL 271+82 TL 279+31 RT 7428 TL 272+25 TL 276+76 LT 1308 TL 279+00 TL 284+82 LT 30021 TL 285+19 TL 285+93 LT 176 TL 285+19 TL 285+93 LT 176 TL 285+69 TL 285+77 RT 32 TL 290+49 TL 293+55 RT 974 TL 293+62 TL 294+80 RT 600 TL 293+57 TL 295+20 LT 860 TL 293+57 TL 295+20 LT 860 TL 313+98 TL 316+62 RT 833 TL 314+07 TL 320+42 LT 2915 TL 328+74 TL 329+88 RT 551 TL 328+74 TL 329+88 RT 551 TL 330+75 TL 335+60 LT 339+00 RT 101 TL 338+80 TL 340+30 LT 3667 TL 338+81 TL 340+30 LT 359 TL 344+00 TL 345+12 LT 153 TL 344+00 TL 345+12 LT 153 TL 351+20 TL 359+89 LT 279 TL 359+22 TL 359+89 LT 279 TL 359+24 TL 359+89 LT 279 TL 36+91 TL 364+33 RT 355 TL 376+28 TL 384+19 RT 1853 TL 376+28 TL 385+29 RT 93 TL 425+07 TL 425+15 RT 83 TL 440+72 TL 441+24 RT 203 TL 445+11 TL 459+55 RT 1247 TL 457+52 TL 458+15 LT 234	STATION		CIDE	1051 (65)
TL 253+00 TL 259+40 RT 2550 TL 255+00 TL 258+29 LT 1094 TL 266+90 TL 267+46 LT 154 TL 268+15 TL 268+92 RT 27 TL 271+82 TL 279+31 RT 7428 TL 271+82 TL 279+31 RT 7428 TL 272+25 TL 276+76 LT 1308 TL 279+00 TL 284+82 LT 3021 TL 285+19 TL 285+93 LT 176 TL 286+69 TL 285+93 LT 1565 TL 286+27 TL 289+35 LT 1565 TL 287+71 TL 289+35 LT 1565 TL 287+71 TL 289+35 RT 974 TL 293+62 TL 295+80 RT 600 TL 293+57 TL 295+80 RT 600 TL 293+57 TL 313+65 RT 2096 TL 313+98 TL 316+62 RT 833 TL 314+07 TL 320+42 LT 2915 TL 326+23 TL 336+64 LT 5725 TL 328+74 TL 329+88 RT 551 TL 338+50 TL 327+27 RT 37 TL 338+50 TL 339+00 RT 101 TL 338+81 TL 340+30 LT 439 TL 349+81 TL 350+83 RT 352 TL 369+44 TL 379+89 RT 553 TL 369+44 TL 350+83 RT 352 TL 369+44 TL 379+89 RT 553 TL 376+95 TL 388+74 RT 355 TL 376+95 TL 388+74 RT 369 TL 376+96 TL 388+74			SIDE	AKEA (SF)
TL 255+00 TL 258+29 LT 1094 TL 266+90 TL 267+46 LT 154 TL 268+15 TL 268+92 LT 319 TL 268+86 TL 268+94 RT 27 TL 271+82 TL 279+31 RT 7428 TL 272+25 TL 276+76 LT 1308 TL 279+00 TL 284+82 LT 3021 TL 285+19 TL 285+93 LT 176 TL 285+19 TL 285+97 RT 32 TL 286+27 TL 289+35 LT 1565 TL 287+71 TL 288+76 RT 495 TL 290+49 TL 293+55 RT 974 TL 293+62 TL 294+80 RT 600 TL 293+57 TL 295+20 LT 860 TL 293+57 TL 295+20 LT 860 TL 313+98 TL 316+62 RT 833 TL 314+07 TL 320+42 LT 5725 TL 327+05 TL 327+27 RT 37 TL 328+74 TL 329+98 RT 551 TL 330+75 TL 336+61 RT 2367 TL 338+50 TL 339+00 RT 101 TL 338+03 TL 340+30 LT 439 TL 344+00 TL 345+12 LT 153 TL 349+81 TL 340+30 LT 439 TL 349+81 TL 350+83 RT 352 TL 351+58 TL 350+83 RT 352 TL 351+58 TL 359+89 LT 279 TL 369+44 TL 370+59 RT 589 TL 369+44 TL 370+59 RT 589 TL 369+44 TL 370+59 RT 589 TL 351+58 TL 350+83 RT 352 TL 369+44 TL 370+59 RT 589 TL 376+28 TL 388+73 LT 4355 TL 389+22 TL 388+74 RT 301 TL 369+44 TL 370+59 RT 589 TL 369+44 TL 370+59 RT 589 TL 376+28 TL 388+74 RT 301 TL 369+44 TL 370+59 RT 589 TL 369+44 TL 370+59 RT 589 TL 376+28 TL 388+74 RT 301 TL 369+44 TL 370+59 RT 589 TL 376+28 TL 388+74 RT 301 TL 369+44 TL 370+59 RT 589 TL 376+28 TL 388+74 RT 301 TL 369+44 TL 370+59 RT 589 TL 376+28 TL 388+74 RT 301 TL 369+44 TL 370+59 RT 589 TL 376+28 TL 388+74 RT 301 TL 369+44 TL 370+59 RT 589 TL 369+44 TL 370+59 RT 589 TL 376+28 TL 388+74 RT 301 TL 369+44 TL 370+59 RT 589 TL 376+28 TL 388+74 RT 301 TL 369+44 TL 370+59 RT 589 TL 369+44 TL 370+59 RT 589 TL 376+28 TL 388+74 RT 301 TL 369+44 TL 370+59 RT 589 TL 369+44 TL 370+59 RT 589 TL 475+91 TL 485+92 RT 99 TL 438+29 TL 439+81 RT 584 TL 440+72 TL 441+24 RT 216 TL 450+10 TL 459+55 RT 1447	TL 249+17	TL 249+80	LT	330
TL 266+90 TL 267+46 LT 154 TL 268+15 TL 268+92 LT 319 TL 268+66 TL 268+94 RT 27 TL 271+82 TL 279+31 RT 7428 TL 272+25 TL 276+76 LT 1308 TL 279+00 TL 284+82 LT 3021 TL 285+19 TL 285+93 LT 176 TL 285+69 TL 285+77 RT 32 TL 286+27 TL 289+35 LT 1565 TL 287+71 TL 289+35 LT 1565 TL 287+71 TL 289+35 LT 1565 TL 290+49 TL 293+55 RT 974 TL 293+62 TL 294+80 RT 600 TL 293+57 TL 295+20 LT 860 TL 293+57 TL 295+20 LT 860 TL 313+98 TL 313+65 RT 2096 TL 313+98 TL 316+62 RT 833 TL 314+07 TL 320+42 LT 2915 TL 326+23 TL 336+64 LT 5725 TL 328+74 TL 329+98 RT 551 TL 338+81 TL 340+30 LT 439 TL 338+81 TL 340+30 LT 439 TL 344+00 TL 343+06 LT 867 TL 344+00 TL 345+12 LT 153 TL 344+01 TL 343+06 LT 867 TL 349+81 TL 350+82 LT 528 TL 349+81 TL 350+83 RT 352 TL 351+58 TL 353+00 LT 279 TL 363+91 TL 352+08 RT 352 TL 351+58 TL 353+00 LT 279 TL 363+91 TL 352+08 RT 352 TL 351+58 TL 353+00 LT 279 TL 363+91 TL 364+33 RT 355 TL 376+28 TL 384+19 RT 1853 TL 376+28 TL 383+73 LT 391+55 RT 93 TL 376+28 TL 383+74 RT 300 TL 391+35 TL 383+73 LT 4355 TL 376+28 TL 383+74 RT 301 TL 391+35 TL 383+27 RT 66 TL 442+49 TL 444+47 RT 203 TL 442+07 TL 425+15 RT 99 TL 438+29 TL 435+29 RT 99 TL 438+29 TL 435+49 LT 4172 TL 450+35 TL 455+49 LT 4172 TL 450+35 TL 455+55 RT 1247	TL 253+00	TL 259+40	RT	2550
TL 268+15 TL 268+92 LT 319 TL 268+86 TL 269+94 RT 27 TL 271+82 TL 279+31 RT 7428 TL 272+25 TL 276+76 LT 1308 TL 279+00 TL 284+82 LT 3021 TL 285+19 TL 285+93 LT 176 TL 285+69 TL 285+77 RT 32 TL 286+27 TL 289+35 LT 1565 TL 287+71 TL 289+35 LT 1565 TL 290+49 TL 293+55 RT 974 TL 293+62 TL 294+80 RT 600 TL 293+57 TL 295+20 LT 860 TL 295+26 TL 300+00 RT 1476 TL 309+42 TL 313+65 RT 2096 TL 313+98 TL 316+62 RT 833 TL 314+07 TL 320+42 LT 2915 TL 326+23 TL 326+24 LT 2915 TL 328+74 TL 329+98 RT 551 TL 338+50 TL 339+00 RT 101 TL 338+81 TL 340+30 LT 439 TL 344+00 TL 345+12 LT 153 TL 344+00 TL 345+12 LT 153 TL 344+00 TL 345+12 LT 153 TL 349+81 TL 350+83 RT 352 TL 351+58 TL 350+83 RT 352 TL 351+58 TL 350+89 LT 279 TL 359+22 TL 388+74 RT 393 TL 351+58 TL 350+89 RT 254 TL 376+28 TL 359+89 LT 279 TL 359+22 TL 359+89 LT 279 TL 359+22 TL 359+89 LT 279 TL 351+58 TL 350+83 RT 352 TL 351+58 TL 350+83 RT 3552 TL 351+59 TL 384+19 RT 1853 TL 376+28 TL 388+74 RT 301 TL 376+29 TL 383+27 RT 6 TL 425+07 TL 425+15 RT 93 TL 425+07 TL 425+15 RT 93 TL 438+29 TL 435+29 RT 99 TL 438+29 TL 435+29 RT 99 TL 438+29 TL 435+29 RT 99 TL 438+29 TL 445+14 RT 1854 TL 450+10 TL 459+55 RT 1247	TL 255+00	TL 258+29	LT	1094
TL 268+86 TL 268+94 RT 27 TL 271+82 TL 279+31 RT 7428 TL 272+25 TL 276+76 LT 1308 TL 279+00 TL 284+82 LT 3021 TL 285+19 TL 285+93 LT 176 TL 285+69 TL 285+77 RT 32 TL 286+27 TL 289+35 LT 1565 TL 287+71 TL 288+76 RT 495 TL 290+49 TL 293+55 RT 974 TL 293+57 TL 295+20 LT 860 TL 293+57 TL 295+20 LT 860 TL 293+57 TL 295+20 LT 860 TL 313+98 TL 316+62 RT 833 TL 314+07 TL 320+42 LT 2915 TL 327+05 TL 327+27 RT 37 TL 328+74 TL 329+98 RT 551 TL 330+75 TL 329+98 RT 551 TL 330+75 TL 336+61 RT 2367 TL 338+81 TL 340+30 LT 867 TL 344+00 TL 343+12 LT 153 TL 344+00 TL 345+12 LT 153 TL 349+81 TL 350+83 RT 352 TL 349+81 TL 350+83 RT 352 TL 351+20 TL 352+08 RT 254 TL 363+91 TL 364+33 RT 345 TL 369+44 TL 370+59 RT 589 TL 363+91 TL 364+33 RT 345 TL 369+44 TL 370+59 RT 589 TL 363+91 TL 364+33 RT 345 TL 369+44 TL 370+59 RT 589 TL 363+91 TL 364+33 RT 345 TL 369+44 TL 370+59 RT 589 TL 364+79 TL 388+74 RT 370 TL 369+44 TL 370+59 RT 589 TL 369+44 TL 370+59 TL 369+20 TL 369+20 TL 369+20 TL 470+10 TL 470+20 TL 470+20 TL 470+10 TL 470+20	TL 266+90	TL 267+46	LT	154
TL 271+82 TL 279+31 RT 7428 TL 272+25 TL 276+76 LT 1308 TL 279+00 TL 284+82 LT 3021 TL 285+19 TL 285+93 LT 176 TL 285+69 TL 285+77 RT 32 TL 286+69 TL 285+77 RT 32 TL 287+71 TL 288+76 RT 495 TL 290+49 TL 293+55 RT 974 TL 293+62 TL 294+80 RT 600 TL 293+62 TL 294+80 RT 600 TL 293+57 TL 295+20 LT 860 TL 295+26 TL 300+00 RT 1476 TL 309+42 TL 313+65 RT 2096 TL 313+98 TL 316+62 RT 833 TL 314+07 TL 320+42 LT 2915 TL 326+23 TL 372+27 RT 37 TL 328+74 TL 329+98 RT 551 TL 330+75 TL 329+98 RT 551 TL 330+75 TL 336+61 RT 2367 TL 338+81 TL 340+30 LT 439 TL 340+71 TL 343+06 LT 867 TL 348+03 TL 350+83 RT 552 TL 349+81 TL 350+83 RT 552 TL 351+20 TL 352+08 RT 254 TL 369+24 TL 359+89 RT 551 TL 369+24 TL 359+89 RT 551 TL 369+24 TL 340+30 LT 439 TL 340+71 TL 345+12 LT 153 TL 369+81 TL 350+83 RT 352 TL 351+20 TL 352+08 RT 254 TL 351+20 TL 352+08 RT 254 TL 369+44 TL 370+59 RT 589 TL 369+24 TL 383+73 LT 4355 TL 369+24 TL 383+73 LT 77 TL 393+24 TL 383+73 LT 77 TL 393+24 TL 383+27 RT 6 TL 406+16 TL 413+60 RT 3167 TL 408+24 TL 410+02 LT 570 TL 414+19 TL 444+47 RT 203 TL 425+07 TL 425+15 RT 83 TL 436+29 TL 439+81 RT 584 TL 440+72 TL 441+24 RT 216 TL 440+72 TL 441+24 RT 216 TL 450+03 TL 455+33 RT 1429 TL 450+03 TL 455+33 RT 1429 TL 450+03 TL 455+33 RT 1429 TL 457+11 TL 459+55 RT 1247	TL 268+15	TL 268+92	LT	319
TL 272+25 TL 276+76 LT 1308 TL 279+00 TL 284+82 LT 3021 TL 285+19 TL 285+93 LT 176 TL 285+19 TL 285+77 RT 32 TL 286+27 TL 289+35 LT 1565 TL 287+71 TL 288+76 RT 495 TL 290+49 TL 293+55 RT 974 TL 293+62 TL 294+80 RT 600 TL 293+57 TL 295+20 LT 860 TL 293+67 TL 300+00 RT 1476 TL 309+42 TL 313+65 RT 2096 TL 313+98 TL 316+62 RT 833 TL 314+07 TL 320+42 LT 2915 TL 326+23 TL 336+64 LT 5725 TL 327+05 TL 329+98 RT 551 TL 330+75 TL 336+61 RT 2367 TL 338+81 TL 340+30 LT 439 TL 340+71 TL 343+06 LT 867 TL 344+00 TL 345+12 LT 153 TL 344+00 TL 345+12 LT 528 TL 349+81 TL 350+83 RT 352 TL 351+20 TL 352+08 RT 254 TL 369+24 TL 359+89 LT 254 TL 369+24 TL 359+89 LT 259 TL 369+24 TL 359+89 LT 551 TL 369+24 TL 359+89 LT 528 TL 369+44 TL 350+83 RT 352 TL 369+24 TL 359+89 LT 279 TL 369+44 TL 370+59 RT 589 TL 369+24 TL 389+98 LT 279 TL 369+24 TL 389+99 RT 589 TL 369+24 TL 359+89 LT 279 TL 369+24 TL 370+59 RT 589 TL 376+28 TL 384+19 RT 1853 TL 375+91 TL 383+73 LT 4355 TL 387+52 TL 388+74 RT 301 TL 393+24 TL 393+27 RT 6 TL 393+24 TL 393+27 RT 6 TL 406+16 TL 413+60 RT 3167 TL 414+19 TL 414+47 RT 203 TL 425+07 TL 425+15 RT 83 TL 436+29 TL 435+29 RT 99 TL 438+29 TL 439+81 RT 584 TL 440+72 TL 441+24 RT 203 TL 425+07 TL 425+15 RT 83 TL 445+01 TL 455+55 RT 1247	TL 268+86	TL 268+94	RT	27
TL 279+00 TL 284+82 LT 3021 TL 285+19 TL 285+93 LT 176 TL 285+69 TL 285+77 RT 32 TL 286-27 TL 289+35 LT 1565 TL 287+71 TL 288+76 RT 495 TL 290+49 TL 293+55 RT 974 TL 293+62 TL 294+80 RT 600 TL 293+57 TL 295+20 LT 860 TL 309+42 TL 313+65 RT 2096 TL 313+98 TL 316+62 RT 833 TL 314+07 TL 320+42 LT 2915 TL 326+23 TL 336+64 LT 5725 TL 327+05 TL 329+98 RT 551 TL 330+75 TL 339+00 RT 101 TL 338+81 TL 340+30 LT 439 TL 344+00 TL 343+06 LT 867 TL 349+81 TL 350+82 LT 528 TL 349+81 TL 350+83 RT 352 TL 351+58 TL 350+83 RT 352 TL 369+44 TL 370+59 RT 589 TL 376+28 TL 388+74 RT 301 TL 387+52 TL 388+74 RT 301 TL 391+35 TL 389+27 RT 589 TL 376+28 TL 388+74 RT 301 TL 393+24 TL 393+27 RT 689 TL 376+28 TL 383+73 LT 4355 TL 391+35 TL 393+27 RT 689 TL 376+28 TL 383+74 RT 301 TL 393+24 TL 393+27 RT 689 TL 376+28 TL 388+74 RT 301 TL 393+24 TL 393+27 RT 68 TL 393+24 TL 393+27 RT 68 TL 393+24 TL 393+27 RT 68 TL 393+24 TL 383+73 LT 7 TL 387+52 TL 388+74 RT 301 TL 393+24 TL 383+27 RT 68 TL 393+24 TL 393+27 RT 68 TL 445+07 TL 425+15 RT 83 TL 445+07 TL 425+15 RT 83 TL 438+29 TL 435+29 RT 99 TL 438+29 TL 435+29 RT 99 TL 438+29 TL 445+14 RT 1854 TL 450+10 TL 455+33 RT 1429 TL 457+11 TL 459+55 RT 1247	TL 271+82	TL 279+31	RT	7428
TL 285+19 TL 285+93 LT 176 TL 285+69 TL 285+77 RT 32 TL 286+27 TL 289+35 LT 1565 TL 287+71 TL 289+35 LT 1565 TL 290+49 TL 293+55 RT 974 TL 290+49 TL 293+55 RT 974 TL 293+62 TL 294+80 RT 600 TL 295+26 TL 300+00 RT 1476 TL 309+42 TL 313+65 RT 2096 TL 313+98 TL 316+62 RT 833 TL 314+07 TL 320+42 LT 2915 TL 327+05 TL 327+27 RT 37 TL 328+74 TL 329+98 RT 551 TL 330+75 TL 336+61 RT 2367 TL 338+81 TL 340+30 LT 439 TL 344+00 TL 343+06 LT 867 TL 344+00 TL 345+12 LT 153 TL 344+00 TL 345+12 LT 153 TL 349+81 TL 350+83 RT 352 TL 351+58 TL 350+83 RT 352 TL 351+58 TL 359+89 LT 279 TL 359+22 TL 359+89 LT 279 TL 363+91 TL 364+33 RT 355 TL 376+28 TL 384+19 RT 1853 TL 376+28 TL 384+19 RT 1853 TL 376+28 TL 383+73 LT 4355 TL 387+52 TL 383+73 LT 4355 TL 391+35 TL 391+55 RT 93 TL 393+24 TL 393+27 RT 301 TL 393+24 TL 393+27 RT 66 TL 406+16 TL 413+60 RT 3167 TL 425+07 TL 425+15 RT 93 TL 425+07 TL 425+15 RT 93 TL 436+29 TL 435+29 RT 99 TL 438+29 TL 435+29 RT 99 TL 438+29 TL 445+14 RT 1854 TL 450+10 TL 459+55 RT 1247	TL 272+25	TL 276+76		1308
TL 285+69 TL 285+77 RT 32 TL 286+27 TL 289+35 LT 1565 TL 287+71 TL 288+76 RT 495 TL 290+49 TL 293+55 RT 974 TL 293+62 TL 294+80 RT 600 TL 293+57 TL 295+20 LT 860 TL 293+57 TL 295+20 LT 860 TL 393+57 TL 300+00 RT 1476 TL 309+42 TL 313+65 RT 2096 TL 313+98 TL 316+62 RT 833 TL 314+07 TL 320+42 LT 5725 TL 327+05 TL 327+27 RT 37 TL 326+23 TL 336+64 LT 5725 TL 327+05 TL 327+27 RT 37 TL 338+74 TL 329+98 RT 551 TL 330+75 TL 336+61 RT 2367 TL 338+81 TL 340+30 LT 439 TL 340+71 TL 343+06 LT 867 TL 344+00 TL 345+12 LT 153 TL 349+81 TL 350+82 LT 528 TL 351+20 TL 352+08 RT 254 TL 351+20 TL 352+08 RT 254 TL 363+91 TL 364+33 RT 345 TL 369+44 TL 370+59 RT 589 TL 376+28 TL 388+74 RT 301 TL 369+44 TL 370+59 RT 589 TL 376+28 TL 388+74 RT 301 TL 376+28 TL 388+74 RT 301 TL 393+24 TL 393+27 RT 37 TL 393+24 TL 393+27 RT 361 TL 393+24 TL 393+27 RT 391 TL 393+24 TL 393+27 RT 60 TL 406+16 TL 413+60 RT 3167 TL 425+07 TL 425+15 RT 83 TL 425+07 TL 425+15 RT 83 TL 425+07 TL 425+15 RT 83 TL 442+49 TL 444+7 RT 203 TL 442+49 TL 444+7 RT 203 TL 442+49 TL 445+14 RT 885 TL 440+72 TL 441+24 RT 216 TL 442+49 TL 445+14 RT 8854 TL 450+10 TL 455+33 RT 1429 TL 457+11 TL 459+55 RT 1247	TL 279+00	TL 284+82	LT	3021
TL 286+27 TL 289+35 LT 1565 TL 287+71 TL 288+76 RT 495 TL 290+49 TL 293+55 RT 974 TL 293+62 TL 294+80 RT 600 TL 293+57 TL 295+20 LT 860 TL 293+57 TL 295+20 LT 860 TL 293+57 TL 295+20 LT 860 TL 309+42 TL 313+65 RT 2096 TL 313+98 TL 316+62 RT 833 TL 314+07 TL 320+42 LT 2915 TL 326+23 TL 336+64 LT 5725 TL 327+05 TL 327+27 RT 37 TL 328+74 TL 329+98 RT 551 TL 330+75 TL 336+61 RT 2367 TL 338+50 TL 339+00 RT 101 TL 338+81 TL 340+30 LT 439 TL 340+71 TL 343+06 LT 867 TL 344+00 TL 345+12 LT 153 TL 348+03 TL 350+22 LT 528 TL 349+81 TL 350+83 RT 352 TL 351+20 TL 352+08 RT 254 TL 351+20 TL 352+08 RT 254 TL 363+91 TL 364+33 RT 352 TL 369+44 TL 370+59 RT 589 TL 376+28 TL 384+19 RT 1853 TL 375+91 TL 383+73 LT 4355 TL 393+24 TL 393+27 RT 6 TL 406+16 TL 413+60 RT 3167 TL 408+24 TL 410+02 LT 570 TL 414+19 TL 414+47 RT 203 TL 425+07 TL 425+20 LT 84 TL 440+72 TL 441+24 RT 203 TL 438+29 TL 439+81 RT 584 TL 440+72 TL 441+24 RT 216 TL 442+49 TL 445+14 RT 1854 TL 450+35 TL 455+33 RT 1429 TL 457+11 TL 459+55 RT 1247				
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TL 414+19 TL 414+47 RT 203 TL 425+07 TL 425+20 LT 84 TL 425+07 TL 425+15 RT 83 TL 434+79 TL 435+29 RT 99 TL 438+29 TL 439+81 RT 584 TL 440+72 TL 441+24 RT 216 TL 442+49 TL 445+14 RT 1854 TL 450+10 TL 451+68 RT 760 TL 450+35 TL 455+49 LT 4172 TL 451+89 TL 455+33 RT 1429 TL 457+11 TL 459+55 RT 1247	TL 406+16	TL 413+60	RT	3167
TL 425+07 TL 425+20 LT 84 TL 425+07 TL 425+15 RT 83 TL 434+79 TL 435+29 RT 99 TL 438+29 TL 439+81 RT 584 TL 440+72 TL 441+24 RT 216 TL 442+49 TL 445+14 RT 1854 TL 450+10 TL 451+68 RT 760 TL 450+35 TL 455+49 LT 4172 TL 451+89 TL 455+33 RT 1429 TL 457+11 TL 459+55 RT 1247	TL 408+24	TL 410+02	LT	570
TL 425+07 TL 425+15 RT 83 TL 434+79 TL 435+29 RT 99 TL 438+29 TL 439+81 RT 584 TL 440+72 TL 441+24 RT 216 TL 442+49 TL 445+14 RT 1854 TL 450+10 TL 451+68 RT 760 TL 450+35 TL 455+49 LT 4172 TL 451+89 TL 455+33 RT 1429 TL 457+11 TL 459+55 RT 1247	TL 414+19	TL 414+47	RT	203
TL 434+79 TL 435+29 RT 99 TL 438+29 TL 439+81 RT 584 TL 440+72 TL 441+24 RT 216 TL 442+49 TL 445+14 RT 1854 TL 450+10 TL 451+68 RT 760 TL 450+35 TL 455+49 LT 4172 TL 451+89 TL 455+33 RT 1429 TL 457+11 TL 459+55 RT 1247	TL 425+07	TL 425+20	LT	84
TL 438+29 TL 439+81 RT 584 TL 440+72 TL 441+24 RT 216 TL 442+49 TL 445+14 RT 1854 TL 450+10 TL 451+68 RT 760 TL 450+35 TL 455+49 LT 4172 TL 451+89 TL 455+33 RT 1429 TL 457+11 TL 459+55 RT 1247	TL 425+07	TL 425+15	RT	83
TL 440+72 TL 441+24 RT 216 TL 442+49 TL 445+14 RT 1854 TL 450+10 TL 451+68 RT 760 TL 450+35 TL 455+49 LT 4172 TL 451+89 TL 455+33 RT 1429 TL 457+11 TL 459+55 RT 1247	TL 434+79	TL 435+29	RT	99
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TL 451+89 TL 455+33 RT 1429 TL 457+11 TL 459+55 RT 1247				
TL 457+11 TL 459+55 RT 1247				
TL 457+52 TL 458+15 LT 234				
	IL 457+52	TL 458+15	<u>L</u> T	234

TABLE OF SITE CLEARING LIMITS

TABLE OF SILT FENCING/FIBER LOG INSTALLATIONS			
ST	ATION	SIDE	LENGTH
FROM	TO	SIDE	LLNOTTI
TL 36+15	TL 38+25	LT	210
TL 36+15	TL 38+25	RT	210
TL 38+50	TL 39+60	RT	110
TL 39+05	TL 96+75	LΤ	5770
TL 40+00	TL 96+75	RT	5675
TL 101+25	TL 172+20	LT	7095
TL 101+25	TL 172+20	RT	7095
TL 172+40	TL 293+40	LT	12100
TL 174+50	TL 239+90	RT	6540
TL 242+85	TL 292+50	RT	4965
TL 295+00	TL 426+75	RT	13175
TL 297+35	TL 384+00	LT	8665
TL 385+65	TL 413+25	LT	2760
TL 416+25	TL 442+00	LT	2575
TL 433+50	TL 460+70	RT	2720
TL 446+25	TL 460+70	LT	1445

294 110

143

REVISED DRAWING 4/30/2024



DESIGN & CONSTRUCTION



WARNING:

VYACINING.

THE ALTERATION OF THIS MATERIAL IN ANY WAY.
UNLESS DONE UNDER THE DIRECTION OF A COMPARABLE
PROFESSIONAL, LE ARCHITECT FOR AN ARCHITECT,
ENGINEER FOR AN ENGINEER OR LANDSCAPE ARCHITECT,
FOR A LANDSCAPE ARCHITECT, IS NO ULOLATED NOT THE
NEW YORK STATE EDUCATION LAW ANDOR REGULATIONS
AND IS A CLASS "IMBEDIMENANCE".



CONSTRUCTION

PROVIDE RECREATIONAL MULTI-USE RAIL TRAIL FLOODWOOD TO TUPPER LAKE

FLOODWOOD TO TUPPER LAKE

NYS DEPARTMENT OF **ENVIRONMENTAL CONSERVATION**


	04/30/24	ADDENDUM #1
	02/15/24	BID DOCUMENTS
MARK	DATE	DESCRIPTION
PROJECT NUMBER:	47	602-C
DESIGNED BY:	C.	D.F.

D.D.A.

MISCELLANEOUS TABLES

C-601

SHEET 133 OF 143

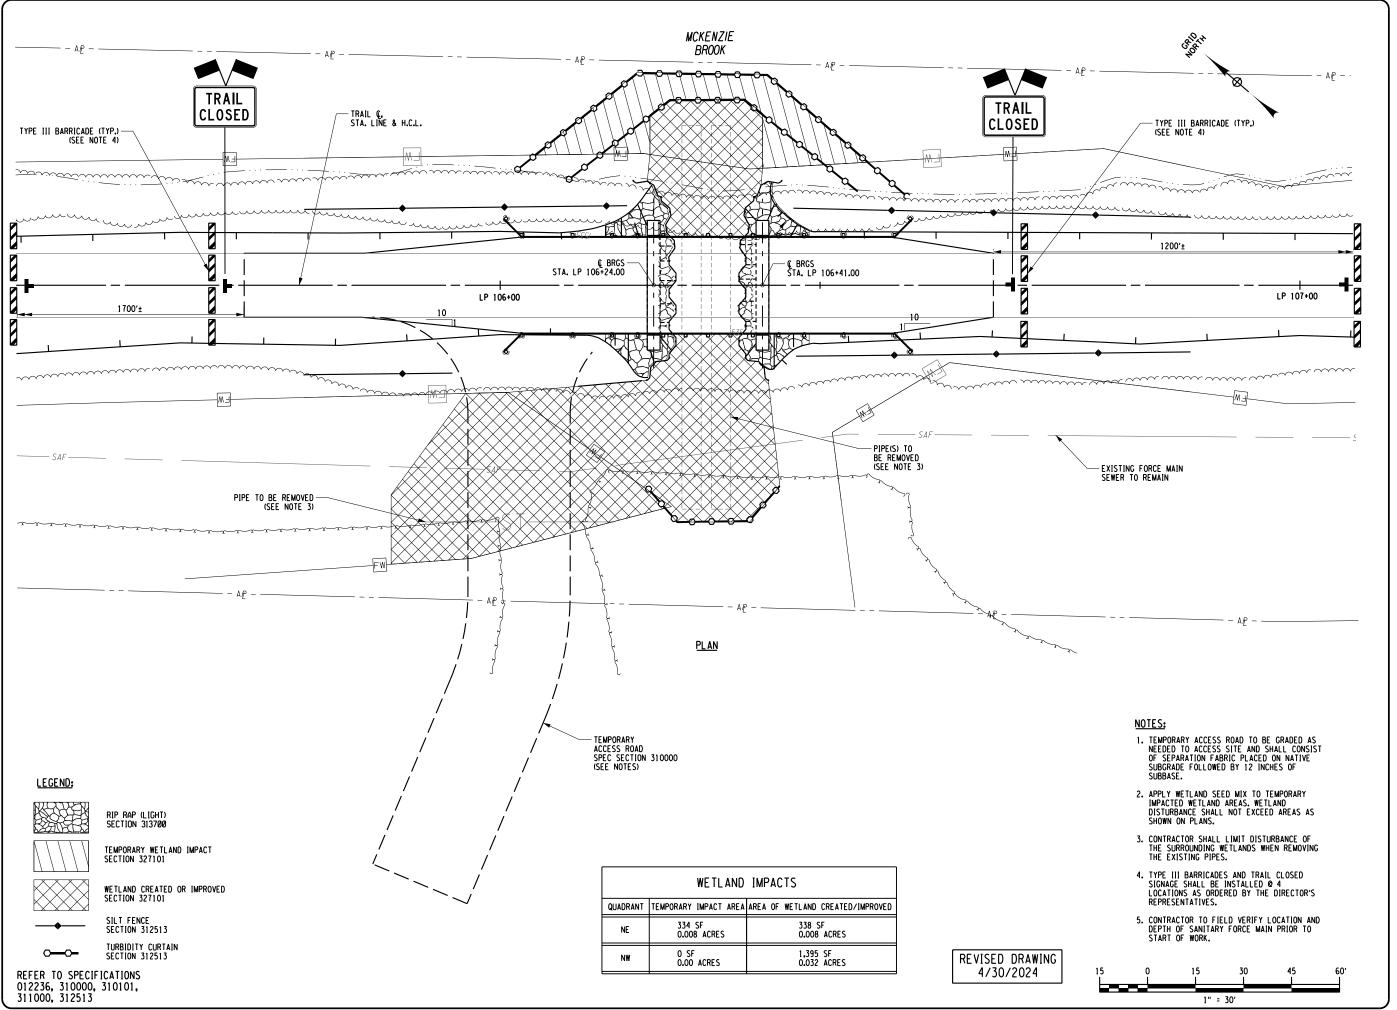



DESIGN & CONSTRUCTION



WARNING:

THE ALTERATION OF THIS MATERIAL IN ANY WAY, UNLESS DONE UNDER THE DIRECTION OF A COMPARABLE PROFESSIONAL, LE ARCHITECT FOR NA ARCHITECT, ENGINEER FOR AN ENGINEER OR LANDSCAPE ARCHITECT, ENGLAMBER ARCHITECT, SA VIOLATION OF THE NEW YORK STATE EDUCATION LAW ANDOR REGULATIONS AND IS A CLASS* A' IMBEDIMENANCE.



CONSTRUCTION

PROVIDE RECREATIONAL MULTI-USE RAIL TRAIL FLOODWOOD TO TUPPER LAKE

ATION:

FLOODWOOD TO TUPPER LAKE

NYS DEPARTMENT OF ENVIRONMENTAL CONSERVATION


	04/30/24	ADDENDUM #1
	02/15/24	BID DOCUMENTS
MARK	DATE	DESCRIPTION
PROJECT NUMBER:	47	602-C
DESIGNED BY:	A.B., L.	F. & L.S

DESIGNED BY: A.B., L.F. & L.S DRAWN BY: K.H.D. FIELD CHECK: 09/12/2023 APPROVED: D.D.A. SHEET TITLE:


EROSION CONTROL SEDIMENT CONTROL PLAN

S-401

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NEW YORK Office of General Services

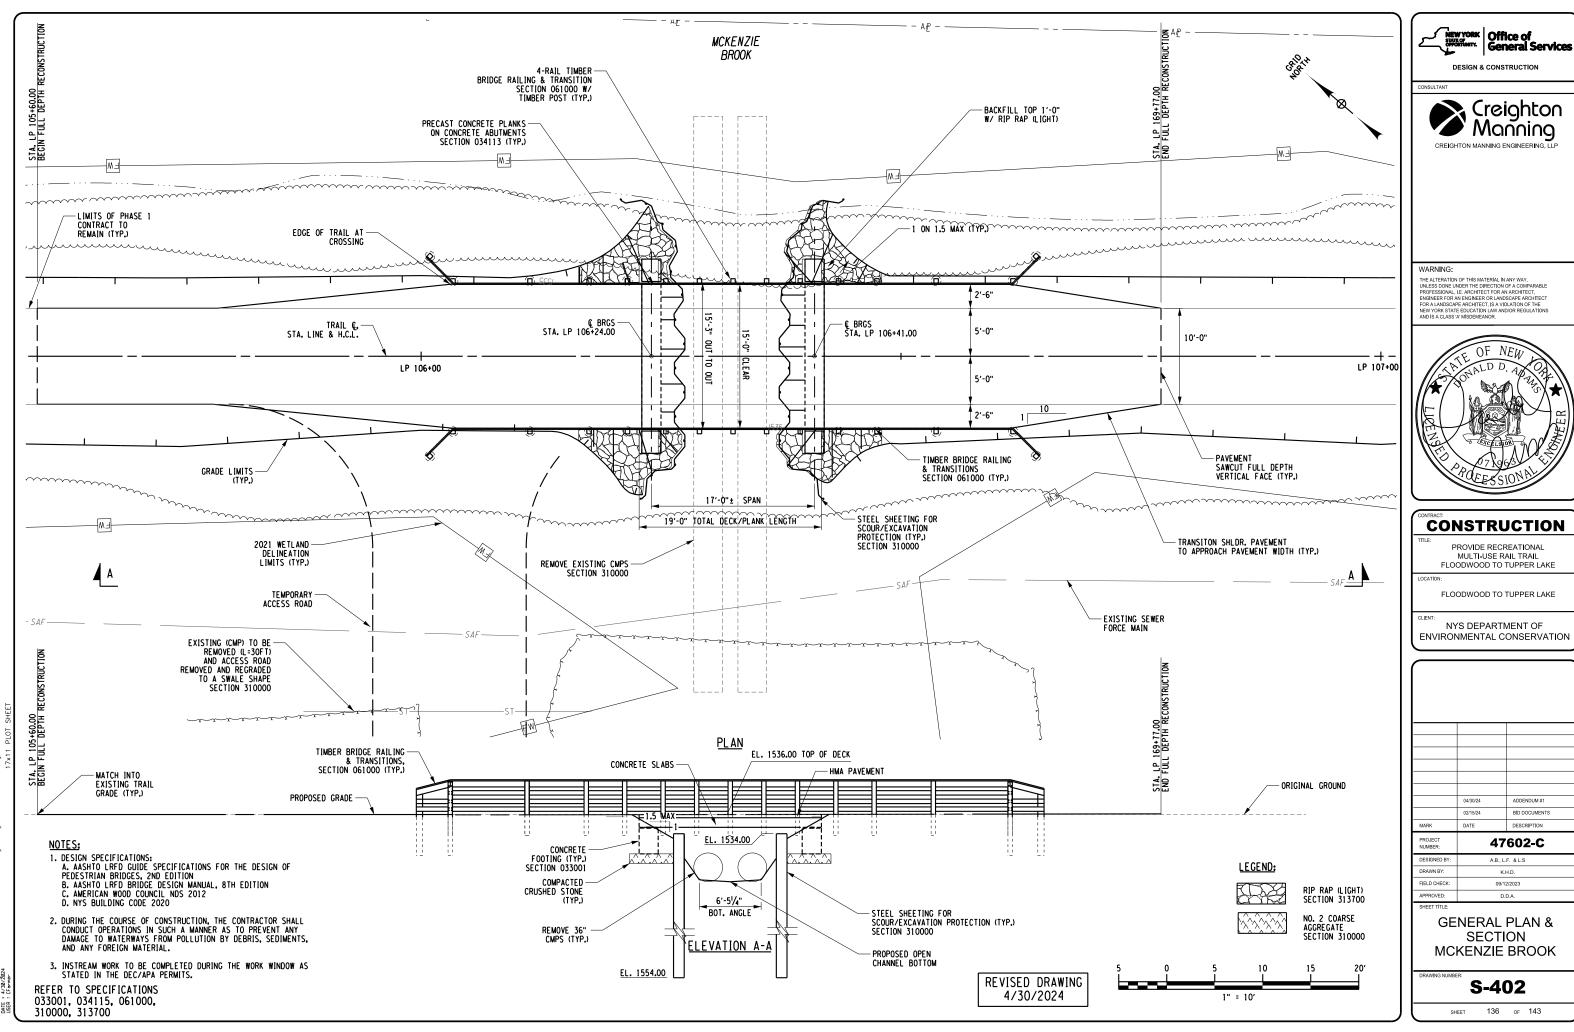DESIGN & CONSTRUCTION

CONSULTANT

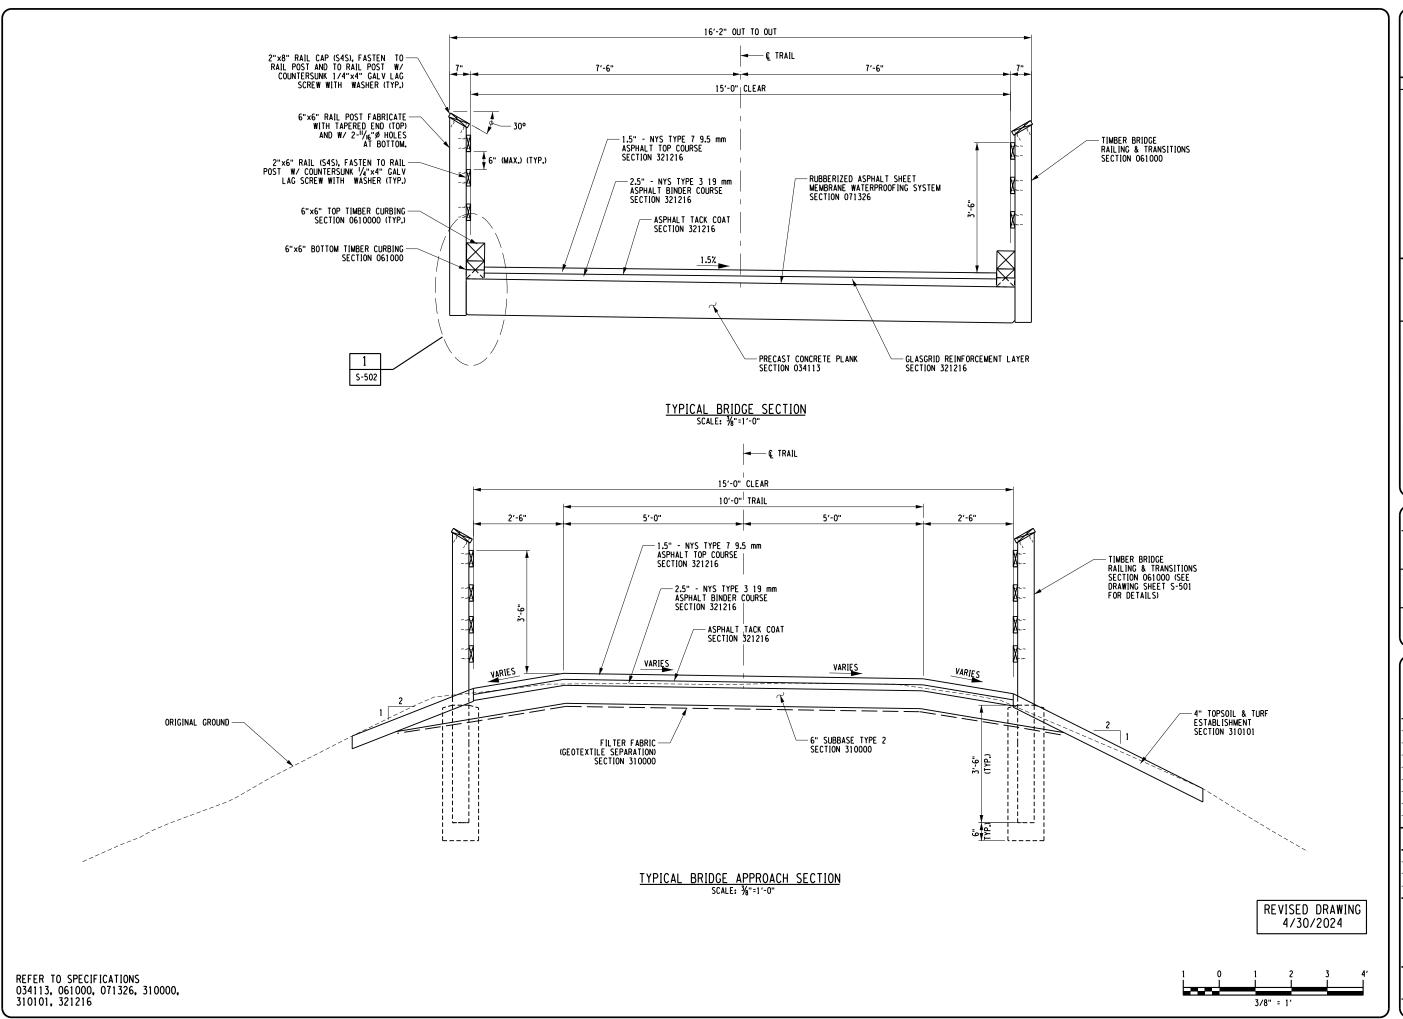

WARNING:

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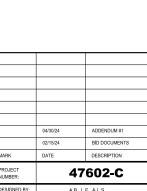
CONSTRUCTION

PROVIDE RECREATIONAL MULTI-USE RAIL TRAIL FLOODWOOD TO TUPPER LAKE

OCATION:

FLOODWOOD TO TUPPER LAKE

CLIENT:
NYS DEPARTMENT OF
ENVIRONMENTAL CONSERVATION




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ı	DESIGNED BY:	A.B., L.F. & L.S
ı	DRAWN BY:	K.H.D.
ı	FIELD CHECK:	09/12/2023
ı	APPROVED:	D.D.A.

TYPICAL SECTIONS MCKENZIE BROOK

S-403SHEET 137 OF 143

ILE = N:\Projects\2005 JATE = 4/30/2024

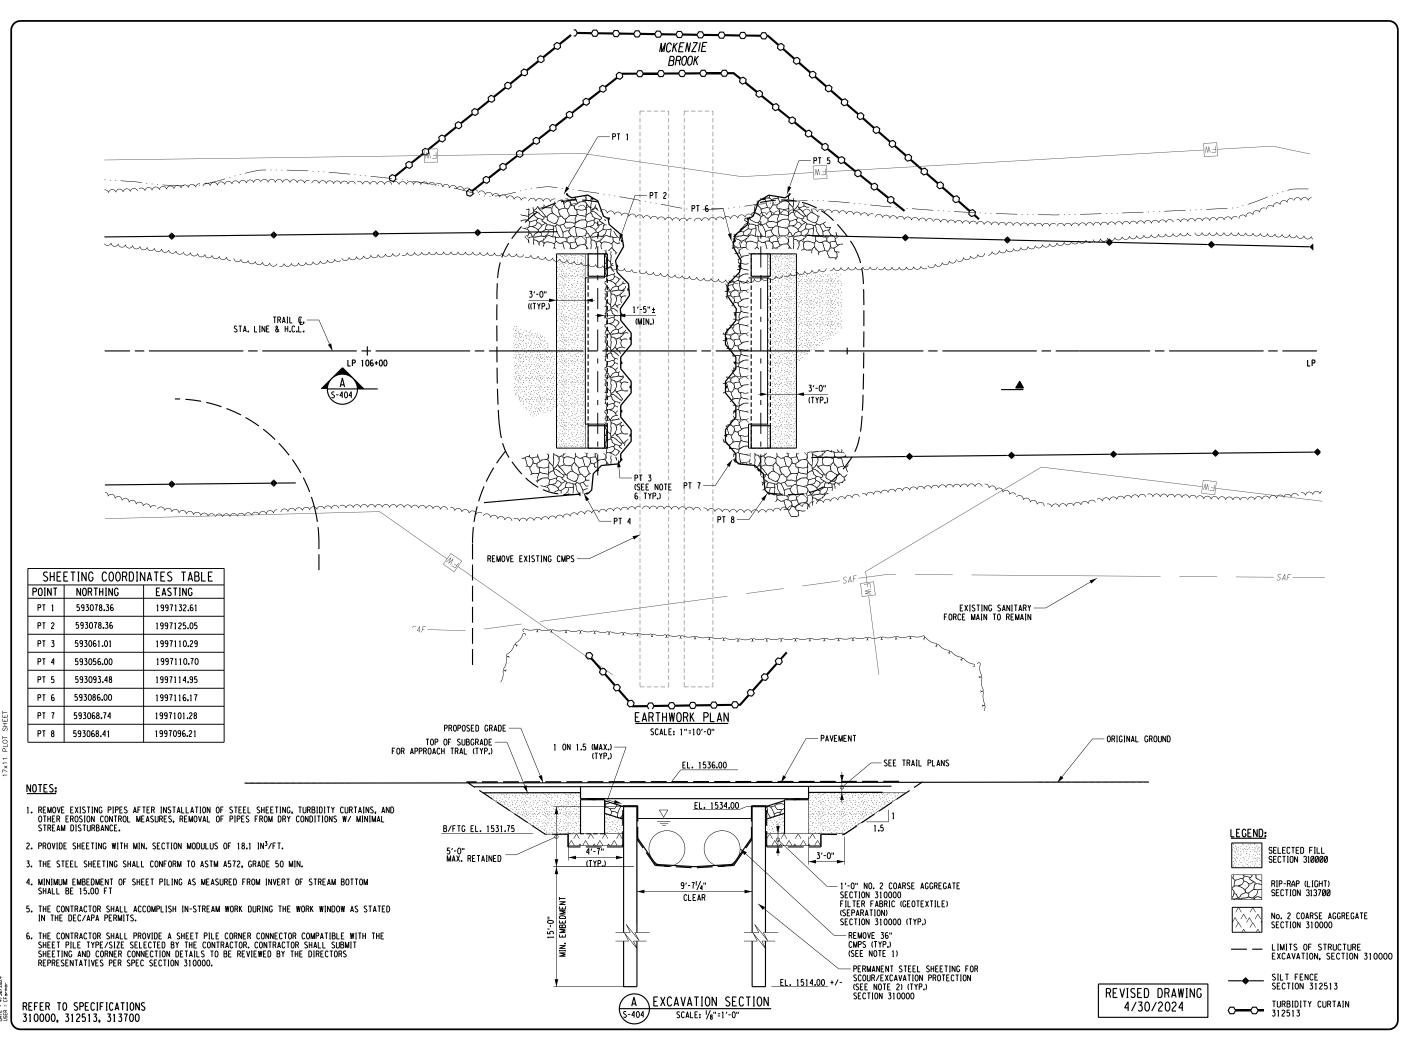



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CONSULTAN



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CONSTRUCTION

PROVIDE RECREATIONAL MULTI-USE RAIL TRAIL FLOODWOOD TO TUPPER LAKE

OCATION:

FLOODWOOD TO TUPPER LAKE

NYS DEPARTMENT OF ENVIRONMENTAL CONSERVATION


	04/30/24	ADDENDUM #1
	02/15/24	BID DOCUMENTS
MARK	DATE	DESCRIPTION
PROJECT NUMBER:	47	602-C

DESIGNED BY: A.B., L.F. & L.S DRAWN BY: K.H.D. FIELD CHECK: 09/12/2023 APPROVED: D.D.A.

EARTHWORK PLAN MCKENZIE BROOK

S-404

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NEW YORK Office of General Services

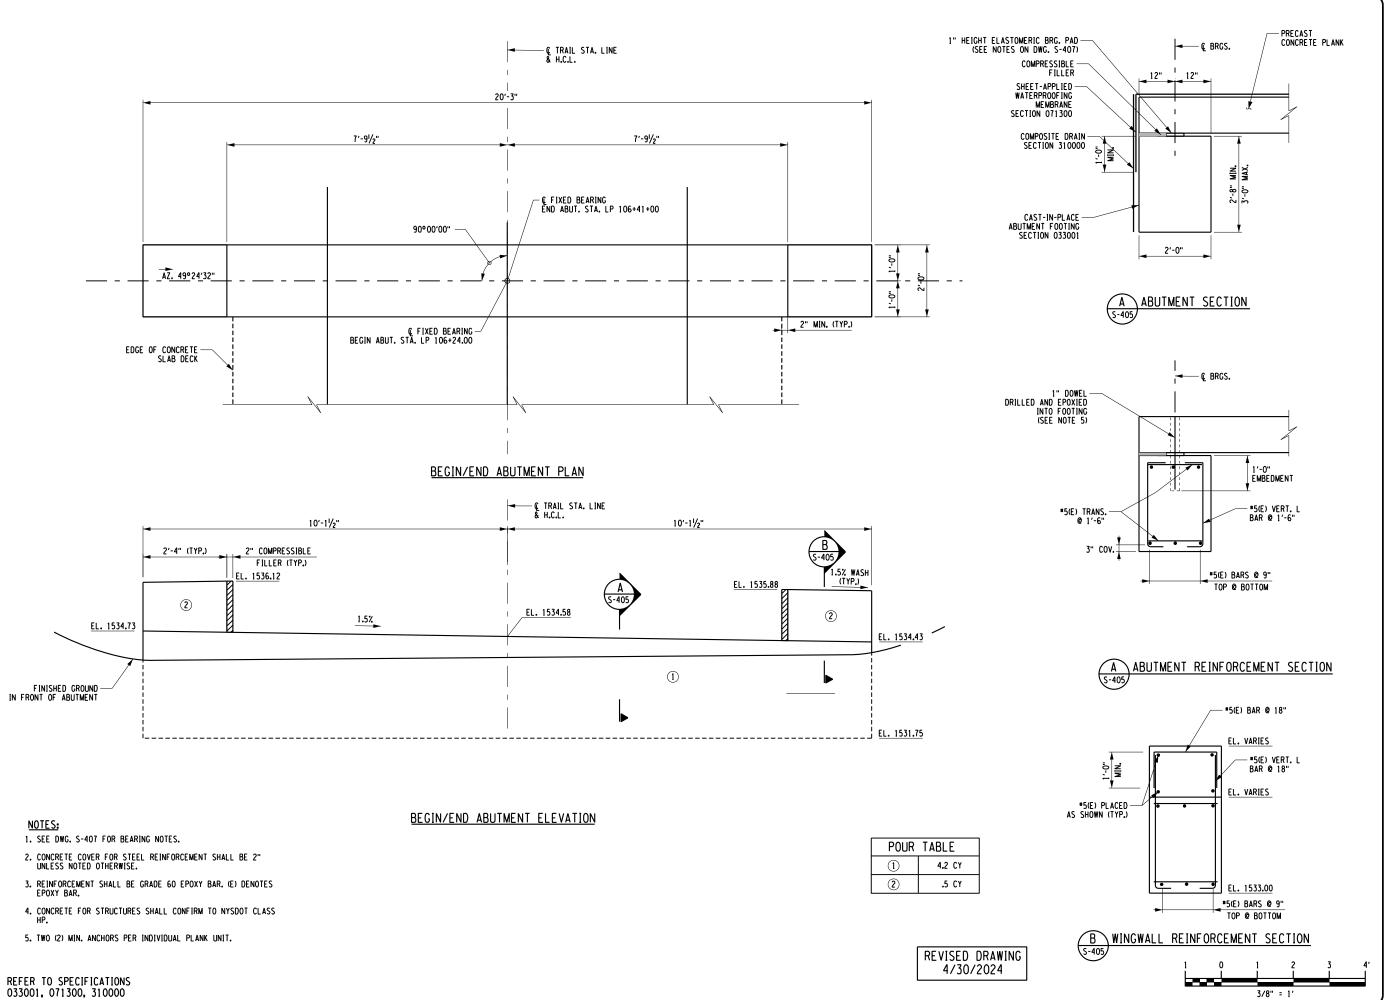DESIGN & CONSTRUCTIO



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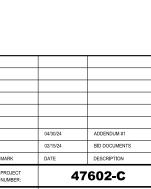
CONSTRUCTION

PROVIDE RECREATIONAL MULTI-USE RAIL TRAIL FLOODWOOD TO TUPPER LAKE

LOCATION:

FLOODWOOD TO TUPPER LAKE

OLIENT:
NYS DEPARTMENT OF
ENVIRONMENTAL CONSERVATION



DESIGNED BY: A.B., L.F. & L.S

DRAWN BY: K.H.D.


FIELD CHECK: 09/12/2023

APPROVED: D.D.A.

ABUTMENT PLAN, ELEVATION & SECTIONS MCKENZIE BROOK

S-405

ET 139 OF 143

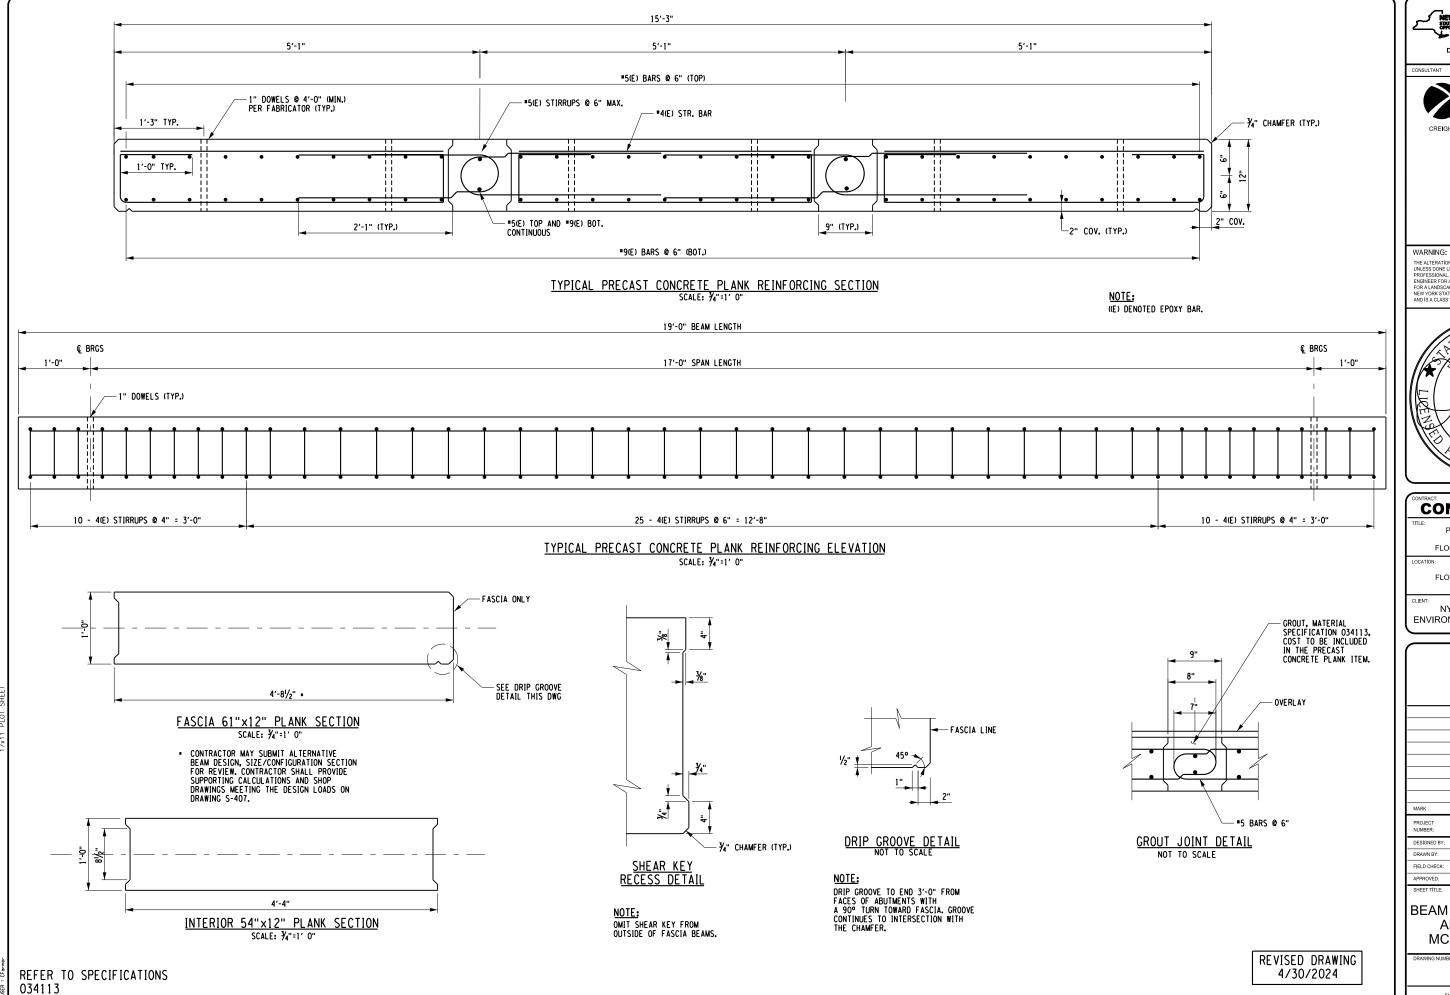

NEW YORK Office of General Services

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CONSTRUCTION

PROVIDE RECREATIONAL MULTI-USE RAIL TRAIL FLOODWOOD TO TUPPER LAKE

FLOODWOOD TO TUPPER LAKE

NYS DEPARTMENT OF ENVIRONMENTAL CONSERVATION

	04/30/24	ADDENDUM #1
	02/15/24	BID DOCUMENTS
MARK	DATE	DESCRIPTION
PROJECT NUMBER:	47	602-C
DESIGNED BY:	4.0.1	

DESIGNED BY:	A.B., L.F. & L.S
DRAWN BY:	K.H.D.
FIELD CHECK:	09/12/2023
APPROVED:	D.D.A.

BEAM REINFORCEMENT AND SECTIONS MCKENZIE BROOK

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4-RAIL TIMBER -BRIDGE RAILING & TRANSITION SECTION 061000 W/

-6"x6" NOM. TIMBER BRIDGE RAILING & TRANSITIONS POST SECTION 061000 TIMBER POST (TYP.)

FRAMING/RAIL PLAN SCALE: 1/8"= 1'-0"

BRIDGE SUPERSTRUCTURE NOTES:

1. THE PRECAST CONCRETE PLANK SUPERSTRUCTURE IS CAPABLE OF SUPPORTING THE FOLLOWING UNFACTORED LOADS:

A. LIVE LOAD: 90 PSF PEDESTRIAN OR AASHTO H-10 VEHICLE B. SNOW LOAD: 106 PSF PER IBC TABLE 1607.12 C. DEAD LOAD:

i. SLAB PANELS: 150 PSF ii. RAILING+CURB: 6 PSF

iii. H.M.A.: 47 PSF
D. WIND: 44 PSF (HORIZONTAL) (VERTICAL)

2. FOR PURPOSES OF CONSTRUCTION LOADING ONLY, THE STRUCTURE IS DESIGNED TO CARRY A MAX. LOAD OF HS-20.

3. CAMBER IS NOT REQUIRED BY BUT MAY BE INCORPORATED AT THE FABRICATORS DISCRETION.

4. THE STRUCTURE IS DESIGNED FOR A MAX DEFLECTION OF L/800 = 1/4" AT MIDSPAN.

5. SHOP DRAWINGS SHALL BE SUBMITTED TO THE DIRECTOR'S REPRESENTATIVE FOR REVIEW AND APPROVAL.

6. ERECTION DRAWINGS AND CALCULATIONS STAMPED BY A LICENSED MYS PROFESSIONAL ENGINEER SHALL BE SUBMITTED TO THE DIRECTOR'S REPRESENTATIVE FOR REVIEW AND

PRECAST CONCRETE PLANK NOTES:

TIMBER BRIDGE RAILING & TRANSITIONS

SECTION 061000 (TYP.)

5′-0"

2′-6"

THE CONCRETE PLANKS SHALL MEET THE REQUIREMENTS OF THE NYSPCCM FOURTH EDITION, MARCH 2023, WITH ALL CURRENT ADDENDUM AND

THE LOCATION AND TYPE OF ALL TEMPORARY/PERMANENT INSERTS SHALL BE APPROVED BY THE DIRECTOR'S REPRESENTATIVE AND DETAILED ON THE PRESTRESSED CONCRETE "WORKING DRAWINGS".

CONCRETE PLANK MATERIAL PROPERTIES SHALL BE PER THE PROECT SPECIFICATIONS, AIR ENTRAINED, AND ACHIEVE A MINIMUM DESIGN COMPRESSIVE STRENGTH OF 5,000 PSI.

4. BAR REINFORCEMENT SHALL MEET ASTM A792, GRADE 60. (E) DENOTES EPOXY COATED REINFORCEMENT. REBAR SHALL BE CONTINOUS WITH NO LAPS IN CONCRETE PLANK SUPERSTRUCTURE COMPONENTS OR AS DETAILED ON PLANS.

5. COVER SHALL BE AS SHOWN ON THE PLANS.

6. ALL EXPOSED CORNERS, EXCEPT THE TOP SHALL BE CHAMFERED ¾".

7. FASCIA BEAMS SHALL BE RUBBED FINISHED WITHIN 4 DAYS OF CASTING.

THE FABRICATOR IS FULLY RESPONSIBLE FOR THE DESIGN OF THE LIFTING DEVICES WHICH WILL BE ADEQUATE FOR THE SAFETY FACTORS REQUIRED BY THE ERECTION PROCEDURES.

REVISED DRAWING 4/30/2024

10'-0"



Creighton ' Mañnina

WARNING:



CONSTRUCTION

PROVIDE RECREATIONAL MULTI-USE RAIL TRAIL FLOODWOOD TO TUPPER LAKE

FLOODWOOD TO TUPPER LAKE

NYS DEPARTMENT OF **ENVIRONMENTAL CONSERVATION**

ADDENDUM #1 BID DOCUMENTS

NUMBER:	47602-C
DESIGNED BY:	A.B., L.F. & L.S
DRAWN BY:	K.H.D.
FIELD CHECK:	09/12/2023
APPROVED:	D.D.A.
CHECK THE C.	

FRAMING AND RAIL PLAN MCKENZIE BROOK

S-407

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RAILING NOTES:

1. FOR TIMBER RAIL AND CURB LAYOUT/NOTES SEE S-502.


1. 6" MIN. WIDTH BEARING PAD CONTINUOUS ALONG FOOTING SUPPORTING THE PRECAST PLANK SUPERSTRUCTURE.

2. ELASTOMERIC BEARING PADS SHALL BE PROVIDED WITH 50-70 DUROMETER HARDNESS ON THE SHORE A SCALE, AND SHALL HAVE A MINIMUM STRENGTH OF 800 PSI.

REFER TO SPECIFICATIONS 061000

BEARING NOTES:

3. CONCRETE SURFACES UNDER THE BEARINGS SHALL NOT BE PREFORMED, IRREGULAR, OR POORLY FINISHED. THE ENTIRE BEARING AREA SHALL BE FLOATED AND TROWELED.

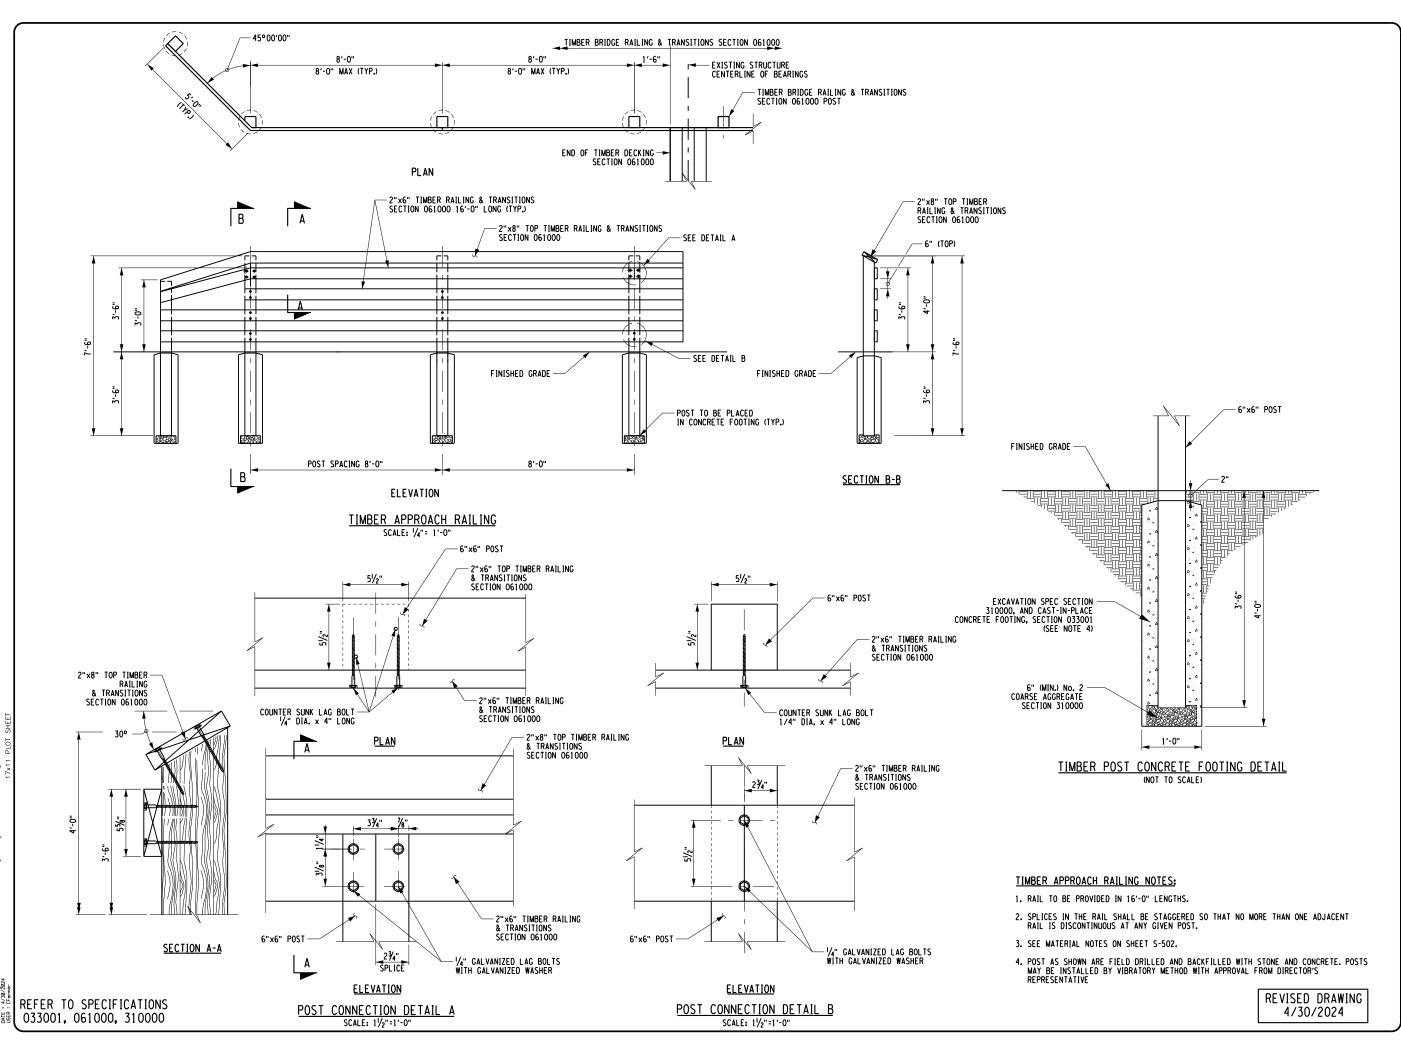



DESIGN & CONSTRUCTION

CONSULTANT



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CONSTRUCTION

PROVIDE RECREATIONAL MULTI-USE RAIL TRAIL FLOODWOOD TO TUPPER LAKE

OCATION:

FLOODWOOD TO TUPPER LAKE

NYS DEPARTMENT OF
ENVIRONMENTAL CONSERVATION

0480/24 ADDENDUM#1
02/15/24 BID DOCUMENTS

MARK DATE DESCRIPTION
PROJECT
NUMBER: 47602-C

DESIGNED BY:	A.B., L.F. & L.S
DRAWN BY:	K.H.D.
FIELD CHECK:	09/12/2023
APPROVED:	D.D.A.

MISCELLANEOUS DETAILS - 1


S-501

ET 142 OF 143

ELEVATION TYPICAL CURB CONNECTION DETAIL SCALE: NTS

1 • 1

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EDGE OF 6"X6" NOM. BOTTOM CURB (TYP.)

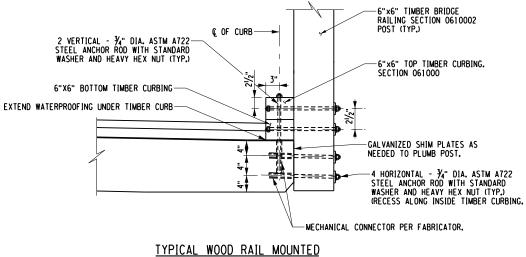REVISED DRAWING 4/30/2024

DESIGN & CONSTRUCTION

Creighton Manning

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CONSTRUCTION

MULTI-USE RAIL TRAIL FLOODWOOD TO TUPPER LAKE

FLOODWOOD TO TUPPER LAKE

NYS DEPARTMENT OF **ENVIRONMENTAL CONSERVATION**

04/30/24 ADDENDUM #1 02/15/24 BID DOCUMENTS DESCRIPTION 47602-C

A.B., L.F. & L.S DRAWN BY: K.H.D. FIELD CHECK: 09/12/2023 APPROVED: D.D.A.

MISCELLANEOUS

S-502

DETAILS - 2

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REFER TO SPECIFICATIONS 061000

DRAINAGE VOID -

ON CONCRETE DECK (NOT TO SCALE)

3. ALL FIELD CUT EDGES AND DRILLED HOLES OF TREATED LUMBER SHALL BE FIELD TREATED WITH A WOOD PRESERVATIVE THAT CONTAINS A MINIMUM 2% COPPER.

1. ALL TIMBER RAILING, POST, AND CURBING SHALL BE SOUTHERN YELLOW PINE GRADE 2 OR BETTER PRESSURE TREATED. TIMBER SHALL BE SIZED PER STANDARD DRESSED SAWN LUMBER. ALL TIMBER DIMENSIONS SHOWN ARE NOMINAL SIZES.

2. ALL TIMBER SHALL BE TREATED WITH AWPA STANDARD UI TO THE REQUIREMENTS OF USE CATEGORY UC4.

4. ALL LAG BOLT CONNECTIONS SHALL BE PRE-DRILLED WITH THE PROPER SIZE LEAD HOLE DIAMETER IN ACCORDANCE WITH THE AITC MANUAL. NO MORE THAN ½6" LARGER THAN THE BOLT DIAMETER.

5. OVERSIZED OR SLOTTED HOLES SHALL NOT USED FOR ANY CONNECTIONS.

6. ALL FASTNERS SHALL BE GALVANIZED.

NOTES:

- END OF BRIDGE

7. CONTRACTOR MAY PROPOSE AN ALTERNATE RAILING AND CURB ANCHORING SYSTEMS PER BRIDGE FABRICATOR RECOMMENDATIONS. CONTRACTOR SHALL SUBMIT SHOP DRAWINGS AND CALCULATIONS FOR REVIEW AND APPROVAL.